

#### TOWN OF ARLINGTON

DEPARTMENT OF PLANNING and COMMUNITY DEVELOPMENT

TOWN HALL, 730 MASSACHUSETTS AVENUE ARLINGTON, MASSACHUSETTS 02476 TELEPHONE 781-316-3090

#### **MEMORANDUM**

To: CDBG Subcommittee From: Mallory Sullivan

Date: April 28, 2022

RE: Off-Cycle CDBG Requests for Funding

#### Overview

#### **Background**

Each year, the Arlington CDBG program allocates its grant award from HUD to numerous Subrecipients who utilize those funds for a range of housing, economic development, public services, public facilities, planning and administrative activities. Some years, Subrecipients do not use their grant in full. This happens for many reasons, including costs being lower than expected, budget changes, or because a project has been canceled altogether. When this happens, these funds become available for reprogramming to new or existing activities.

#### Available Funding

We currently have \$543,000 to be reprogrammed from 2015-2021 grants.

#### What types of activities can and can't be funded?

These funds can be used to make grants to Affordable Housing, Public Facilities, and Economic Development projects. Due to HUD's statutory caps that limit the amount of funding that can be dedicated to Public Services, Planning, and Administration activities, funds cannot be reprogrammed to these activities without impacting current year budgets.

#### **Process**

Throughout the year, the Town receives inquiries about available funding for many different projects. When those projects align with CDBG goals, but the timelines don't fit into the CDBG funding cycle, we retain project information. If funds become available during the year, these organizations are invited to submit a request for funding. Requests are then reviewed by the CDBG Subcommittee. In order to formalize any changes and make grants in accordance with HUD policy, the CDBG Administrator determines whether the change constitutes a "substantial change" to the CDBG Annual Action Plan. The process for making substantial changes to CDBG Annual Action Plans is outlined on Page 2-3 of the CDBG Citizen Participation Plan. For changes that are not considered "substantial," the CDBG Subcommittee's approval is the necessary endorsement that enables a Subrecipient Agreement to be issued to the applicant.

#### Off-Cycle CDBG Requests & Staff Recommendation

There are currently two viable requests for funding that meet CDBG objectives and that are ready, or nearly ready, to begin work. Each of the interested parties has provided a request for funding, included in the attachments and noted below. The CDBG Subcommittee will review these applications. Any comments, questions, or concerns should be sent directly to me.

If these requests are funded at the level of request, approximately \$93,000 will remain in unspent CDBG funds available from prior year grants. These funds will remain available to be programmed to future eligible projects.

Applicant	Proposed Project	Requested Funds	Recommended Funds	Origin Year Grant	Substantial Amendment triggered?
Arlington Housing	Hauser Building Fire Suppression	\$350,000	\$350,000	2021	YES
Authority	System Upgrades				
Arlington Recreation	Parmenter Playground	\$100,000	\$100,000	2019	NO
Department	Construction				

#### **TOWN OF ARLINGTON**

#### COMMUNITY DEVELOPMENT BLOCK GRANT

FUNDING APPLICATION: PART II

PROGRAM YEAR 47 (JULY 1, 2021 – JUNE 30, 2022)

Agency & Project Summary Information				
I. Contact & Organizational Information (If application is completed by a Collaborative, provide the lead entity contact only)				
Agency/Organization: Arlington Recreation				
Contact Name: Joseph Connelly	Title: Director of Recreation			
Mailing Address: 422 Summer Street, Arlington, MA 02474				
Email Address: jconnelly@town.arlington.ma.us	Phone: 781-316-3889			
DUNS #:  (Note: All entities receiving federal assistance are required to have a DUNS #)	Registered on SAM.gov? Yes No (Note: All entities receiving federal assistance are required to be registered on SAM.gov)			
Please Identify the Type of Organization Applying for Formula 501(c)3 For-profit authorized under 570.201(o) Organization	d Institution of Higher Education			
Collaborative Partners: If this application is being submitted on	behalf of a collaborative please identify all partnering agencies here.			
II. Project Information & Eligibility				
Project Name: Parmenter School Playground Renovation				
Anticipated Start Dates: Design 9/1/2021, Construction 4/1/2022	Anticipated End Dates: 8/1/2022			
Amount of Request: \$250,000	Project Location: 17 Irving Street Arlington,MA			
Eligibility: This project/activity must meet ONE of the HUD N				
Low/Moderate Income Area Benefit (LMA): the project/a	activity meets the needs of persons residing in an area where at e. Please refer to the PROJECT/ACTIVITY SERVICE AREA map on Part			
356702.3				
Low/Moderate Limited Clientele (LMC): the activity benefits a group of persons (rather than residents in a particular area) 51% of whom themselves or their family make a low- or moderate-income. The following groups are presumed to be eligible: abused children, battered spouses, elderly persons, adults meeting the Bureau of Census' Current Population Reports definition of "severely disabled", homeless persons, illiterate adults and persons living with AIDS.				
Low/Moderate Housing (LMH): The project will provide or improve permanent residential structures which, upon completion, will be occupied by households that make a low- or moderate-income. This includes but is not limited to acquisition or rehabilitation. Housing can be either owner or renter occupied units in one family or multi-family structures.				
Slum or Blighted Area (SBA): the project is in a designated slum/blighted area as defined under State or local law and will address conditions that qualified the area as slum or blighted.				
Spot Blight (SBS): the project will prevent or eliminate specific conditions of blight or physical decay outside a slum area. Activities are limited to clearance, historic preservation, rehabilitation of buildings, but only to the extent necessary to eliminate conditions detrimental to public health and safety.				
Does your project/activity benefit any of the following?  Abused children  Homeless persons  Persons living with AIDS  Does your project/activity benefit any of the following?  Elderly persons (ag  Severely disabled a	adults (as defined by Bureau of Census*)			

III. Project Summary
1. Brief Project Description (please avoid using abbreviations)  The Parmenter Playground is in dire need of repair and renovation. In the 2019 Town Wide Playgound Audit the Pamenter Playground was determined to be a Hazard 1 playground which means potential for loss of life, permanent disability or body part. The playground auditor stated that the playground should be on the priority list for repair and renovation.
The goal of this project would be to renovate the current playground area and replace with a new playground design with a play structure and play components.
2. Consolidated Plan Goals and Objectives The goal is to provide the neighborhood with a safe, creative, and fun playground for children and families to use that meets all current ADA and Consumer Product Safety standards.
3. Geographic Distribution of Activities: (Town wide, or Census Tract)  The playground is located in a neighborhood pocket park and will provide direct local playground options to the residents of census block group 356702.3. The old Parementer School also currently houses the Menotomy Preschool and Arlington Children's Center. Both of these in town children service organization will receive the benefit of a new playground. The playground is also available to the entire Town of Arlington population.
IV. Attachments
The following attachments must accompany this proposal:  501(c)(3) Letter of Tax Determination Status from the Internal Revenue Service (IRS)  One (1) copy of agency's most recent financial audit  One (1) copy of agency's MA Certificate of Good Standing
The following attachments are options:  Letters of Support  Resumes, brochures, newspaper articles, or other organizational marketing materials
Project Narrative  Based on the evaluation criteria identified, use the space provided to answer each prompt

1. a) Community Need: Please discuss the community need that will be addressed through your proposed project, and your familiarity with said community need. Project goals must be consistent with the Priority Need categories identified in the 5-Year Consolidated Plan.

As stated the renovation of the Parmenter Playground will assist the Town of Arlington in its efforts to upgrade and renovate their town playgrounds as recommended in the 2019 Town Wide Playground Audit.

The Parmenter Playground is in dire need of repair and renovation. In the 2019 Town Wide Playgound Audit the Pamenter Playground was determined to be a Hazard 1 playground which means potential for loss of life, permanent disability or body part. The playground auditor stated that the playground should be on the priority list for repair and renovation.

1. b) Beneficiaries: Will all clients be residents of Arlington? If not, please provide a percentage of non-Arlington residents. Yes	1. c) Beneficiaries: Does this activity address any of the following? Select all that apply.  ➤ Help Prevent Homelessness?  Yes No  ➤ Help the Homeless?  Yes No  ➤ Help Those with HIV/AIDS? Yes No  ➤ Help Persons with Disabilities? Yes No
2 Parameter 9 Court in the state of the stat	
2. Resources & Capacity: Please discuss the staff and resource with the community need and how said need/population will be The project would be under the jurisdiction of the A Commission has been responsible for millions of Recreational Facilities including dozens of playgro	contacted & engaged. Arlington Park Commission. The Arlington Park dollars worth of renovations to Town of Arlington
The project will be directly staffed/supervised by the Director of Recreation.	ne Arlington Recreation Department and the
There will be a full public outreach process during three public meetings.	the design phase that will include no less than
3. Encouraging Partnerships: Does the proposed project involute community? Please Explain.  N/A	ve new or existing partnerships with other service providers in
4. Cost Benefit: Describe how the overall cost of your proposed example, divide the funding request by the estimated number of people served= \$100/person.  Although the Parmenter Playground's anticipated the old Parmenter School, the playground would be Arlington. With a population of 43,000 residents the	people served by this program: \$10,000 funding request /100 use is the direct neighborhood and the tenants of e open and available to the entire Town of

<b>5. Leveraged Funds:</b> Has the organization secured additional funding sources or in-kind support to cover the proposed project?
Arlington Recreation will be receiving \$100,000 from the State of Massachusetts for general playground improvement and plans to use those funds for the Parmenter School Playground renovation project.
<b>6. Self Sufficiency:</b> Will the proposed project be self-sufficient and no longer require CDBG funds after one year? After 3 years? The program would be self-sufficient after the initial construction and the long term maintenance cost would be the responsibility of the DPW and Recreation Department operating budgets.
7. New Public Services Program: Is the proposed project offering a new service and is it available from any other providers in
the community? N/A
N/A
8. Additional Comments: If necessary, use this space to include additional project information not covered in the categories above.  The renovation of the Parmenter School Playground in FY 22 would assist the Park and Recreation Commission in their multi year capital improvement plan by moving the Parmenter School planned

expenses and full	ding sources ir		tification of a pro		ne Town ma	cable. Include all proposed ay request a detailed budget.
A. Non-Constru	ction Project	s/Activities (Pu	blic Services, E	conomic Developn	nent)	
Description		Α		B		A+B
•		CDBG Funds	s Requested	Other Fund	ing	Total Proposed Budget
TOTAL PROPOS	TD BUDGET					
TOTAL PROPOS	DED BODGET					
B. Construction	Projects (Ho	using, Public Fa	ncilities) Note: Fe	ederal wage rates ma	ay apply foi	r some construction projects.
		to speak with Tov	wn of Arlington s	taff before submittir		ation for a physical project.
Descrip	tion		A s Requested	B Other Fund	ing	A+B Total Proposed Budget
Construction		CDDG Tulius	s nequesteu	Other runa	ıııg .	Total FToposed Budget
Acquisition						
Appraisals/Studie	S					
Design						
Other:						
Other:						
TOTAL PROPOS	ED BUDGET					
					funding cor	nmitted or pending for this
project, if applical	ble. (Do not in Inding Source			this application)		committed or Pending
	mumg Jource		All	louit		ommitted of Fending
Other Federal:						
State:						
State:						
State: Local:						
State:  Local:  Private:  Total:	sa this snaca to	o share more info	rmation about se	acured or pending le	veraged fu	nds and in-kind support
State:  Local:  Private:  Total:	se this space to	o share more info	ormation about se	ecured or pending le	veraged fu	nds and in-kind support.
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State:  Local:  Private:  Total:	se this space to	o share more info	ormation about se	ecured or pending le	veraged fu	nds and in-kind support.
State:  Local:  Private:  Total:  Applicants may us						
State:  Local:  Private:  Total:  Applicants may us  D. Cost-Benefit Divide the funding	<b>Analysis:</b> Deag request by the	scribe how the CI ne estimated num	DBG costs of you ober of people se	r proposed project re	elate to the	nds and in-kind support.  beneficiaries of the project.
State:  Local:  Private:  Total:  Applicants may us  D. Cost-Benefit Divide the funding	<b>Analysis:</b> Deag request by the	scribe how the CI ne estimated num	DBG costs of you ober of people se	r proposed project re	elate to the	
State:  Local:  Private:  Total:  Applicants may us  D. Cost-Benefit Divide the funding	<b>Analysis:</b> Deag request by the	scribe how the CI ne estimated num	DBG costs of you ober of people se	r proposed project re	elate to the	
State:  Local:  Private:  Total:  Applicants may us  D. Cost-Benefit Divide the funding Example: \$10,000	<b>Analysis:</b> Deg g request by the funding reque	scribe how the CI ne estimated num est /100 proposed	DBG costs of you nber of people se d beneficiaries= \$	r proposed project re rved by this progran \$100 per beneficiary	elate to the n.	beneficiaries of the project.
State:  Local:  Private:  Total:  Applicants may us  D. Cost-Benefit Divide the funding Example: \$10,000	Analysis: Deig request by the funding request TOTAL CDBG	scribe how the CI ne estimated num	DBG costs of you nber of people se d beneficiaries= \$ DUNT: \$	r proposed project re	elate to the n.	beneficiaries of the project.
State:  Local:  Private:  Total:  Applicants may us  D. Cost-Benefit Divide the funding Example: \$10,000	Analysis: Deig request by the funding request	scribe how the CI ne estimated num est /100 proposed REQUEST AMO OSED BENEFICIA	DBG costs of you nber of people se d beneficiaries= \$ DUNT: \$ ARIES: #	r proposed project re rved by this program \$100 per beneficiary = \$	elate to the	beneficiaries of the project.  PER BENEFICIARY
State:  Local:  Private:  Total:  Applicants may us  D. Cost-Benefit Divide the funding Example: \$10,000	Analysis: Deig request by the funding request	scribe how the CI ne estimated num est /100 proposed REQUEST AMO OSED BENEFICIA	DBG costs of you nber of people se d beneficiaries= \$ DUNT: \$ ARIES: #	r proposed project re rved by this program \$100 per beneficiary = \$	elate to the	beneficiaries of the project.
State:  Local:  Private:  Total:  Applicants may us  D. Cost-Benefit Divide the funding Example: \$10,000	Analysis: Deig request by the funding request	scribe how the CI ne estimated num est /100 proposed REQUEST AMO OSED BENEFICIA	DBG costs of you nber of people se d beneficiaries= \$ DUNT: \$ ARIES: #	r proposed project re rved by this program \$100 per beneficiary = \$	elate to the	beneficiaries of the project.  PER BENEFICIARY
State:  Local:  Private:  Total:  Applicants may us  D. Cost-Benefit Divide the funding Example: \$10,000	Analysis: Deig request by the funding request	scribe how the CI ne estimated num est /100 proposed REQUEST AMO OSED BENEFICIA	DBG costs of you nber of people se d beneficiaries= \$ DUNT: \$ ARIES: #	r proposed project re rved by this program \$100 per beneficiary = \$	elate to the	beneficiaries of the project.  PER BENEFICIARY
State:  Local:  Private:  Total:  Applicants may us  D. Cost-Benefit Divide the funding Example: \$10,000	Analysis: Deig request by the funding request	scribe how the CI ne estimated num est /100 proposed REQUEST AMO OSED BENEFICIA	DBG costs of you nber of people se d beneficiaries= \$ DUNT: \$ ARIES: #	r proposed project re rved by this program \$100 per beneficiary = \$	elate to the	beneficiaries of the project.  PER BENEFICIARY

Part II. Project Budget

#### **Performance and Outcome Measurement** MEASURING ACCOMPLISHMENTS TABLE PLEASE AVOID ABBREVIATIONS NEED **OUTPUTS** GOAL **INPUTS OUTCOMES ACTIVITIES STATEMENT** Description of Proposed goals to What the **Direct products of** ST (Short Term) Resources to be LT (Long Term) Need to be reduce extent of dedicated or program does program activities Addressed problems or needs utilized to meet with the input to **Benefits that result** proposed goals fulfill its mission from the program Non compliant Compliant Renovate Kids at Play Safe, Creative, Funding Plaground Playground Playground Compliant Playground

Nationally Reportable Outputs	
Please indicate the	number of outputs expected
Businesses Assisted	Persons Served
Households Assisted	Jobs Created

#### **Performance Evaluation Plan**

Explain your plan for evaluating the progress and results of your project.

The newly renovated playground will be inspected prior to opening by a certified playground inspector for all ADA and saftery compliance.

Email your completed grant application and required attachments to: mjsullivan@town.arlington.ma.us.

PLAYGROUND NAME & ADDRESS: Peirce, 85 Park Ave

DATE OF SITE VISIT: 10.12.2019

AGE APPROPRIATE:

2-5 YRS

☑ 5-12 YRS

2-12 YRS

MANUFACTURER and YEAR OF ORIGINAL INSTALL: Landscape Structures, Inc., 1998

**OVERALL CONDITION OF PLAYGROUND:** 

POOR: HAZARD 1: Loss of life, Permanent disability or body part.

Condition should be corrected immediately.

☑ FAIR: HAZARD 2: Serious injury or illness resulting in temporary disability.

Condition should be corrected as soon as possible.

GOOD: HAZARD 3: Minor [non-disabling] injury/Non-Compliant

Condition should be corrected when time allows.

#### 1. GENERAL SITE CONDITIONS AND APPROACH

Access to the playground is good. There is access from 3 different sides of the playground. There are good site lines from all sides. Located in a residential setting with homes on all sides. Next to the playground is a basketball court and a several pieces of fitness-type equipment.

#### 2. VISUAL SURFACING REVIEW

The surfacing is in fair condition. Weeding and a 'top off' of EWF is needed. The site has a good linear layout that prevents the splay and loss of EWF.

#### 3. COMPONENT STRUCTURE REVIEW

There is evidence of the lack of maintenance, especially with moving parts. The red cable pieces have snapped, incorrect hardware has been installed on a component, and the swings need new hardware. There is evidence of heavy wear and tear on the decks and components. Parts and maintenance is needed now to allow a longer life at the site.

#### 3. COMPONENT STRUCTURE REVIEW

The equipment is a mixture of wood, metal and plastic.

Remove the front spiral slide and board the top now. The slide is cracked and cannot be replaced, as the Manufacturer is no longer in business.

Order seven [7] pieces of four [4] links of chain. This can be done through any Manufacturer. The age of the equipment and inability to retrofit may indicate the need for removal of equipment and surface.

#### 4. FREE STANDING EQUIPMENT [INCLUDING SWINGS]

Rubber tires are buried in the ground. They are very slippery and full of debris. A tire swing has been removed. Remove the tires.

#### 5. SUMMARY/RECOMMENDATIONS


- Remove and replace the links.
- Cut back vegetation.
- If the school <u>uses</u> the playground, they should be aware that the equipment is in 'fair to poor' condition.


  Efforts may be made to repair the equipment as an interim step.
- If the school <u>does not use</u> the playground, a few independent pieces of equipment could be considered for the future.
- This playground could be on the priority list, but first, the user needs to be identified [school and/or neighborhood].
- If the Pre-K children are using this site, I recommend <u>not allowing</u> them to use the site, as it is not age appropriate.
- In my professional opinion, I suggest to remove and replace the swings with a 5-12 climbing net.



## **ADDITIONAL PLAYGROUND PHOTOS**



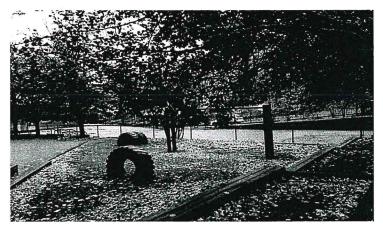

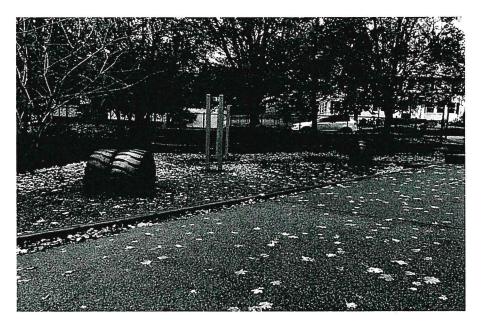





## **ADDITIONAL PLAYGROUND PHOTOS**







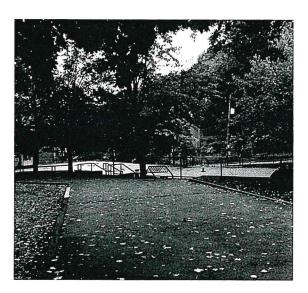

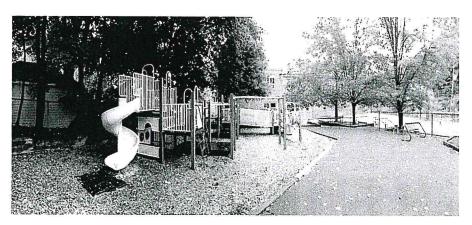

Arlington Inspection Report | Additional Photographs













#### **Assessment Notes**


- Improvements to ADA accessibility are necessary to and from play equipment and access points. A hybrid use of safety surface materials is preferred (rubber for accessibility and high wear areas, wood fiber for others).
- Site needs an entire playground redesign offers an opportunity to really get creative.
- Existing **retaining walls** have cracks need to be addressed.
- · Arlington has record drawings.
- As building use changes, so does use and frequency of playground.
- · Maintain storage shed(s).
- · Gets a lot of use from adjacent neighborhood.
- · Would like half-court basketball and 4-square.
- · Asphalt area does not need to be fully retained.
- Focus play for younger children.
- A good example of a pocket park to look at is Hibbert Playground


#### **Photo Legend**

- 1. General Overview: Parmenter Playground is located next to the Arlington Children's Center; the use of this abutting building is ever-changing. This approximate 2,025 sf site has significant grade change that has been addressed with retaining walls, stairs, and ramps. The play area includes one main play structure and some tire climbing elements. There is a large expanse of 'hot top' asphalt used as play courts and currently outdoor learning facilities.
- Accessibility: ADA accessibility is lacking due to mulch material and wood edging throughout. Existing ramps connect playground with courts. Parking for the playground is unclear.
- 3. Furnishings: Two benches and planter edges are possibilities for current seating. There is a storage shed on asphalt area.
- 4. Edges: The playground is fenced on all sides. Retaining walls enclose one side of the asphalt area and drop off on the other side. Cracks need to be addressed.
- Character: Current theme is not as evident as most of the other playgrounds in this report. School use and elevation change are the major existing characteristics.
- Vegetation: Edge trees and healthy planter trees provide adequate shade for playground, while asphalt is in need of more sun protection.

# **Conditions Assessment**


Parmenter Playground & Courts

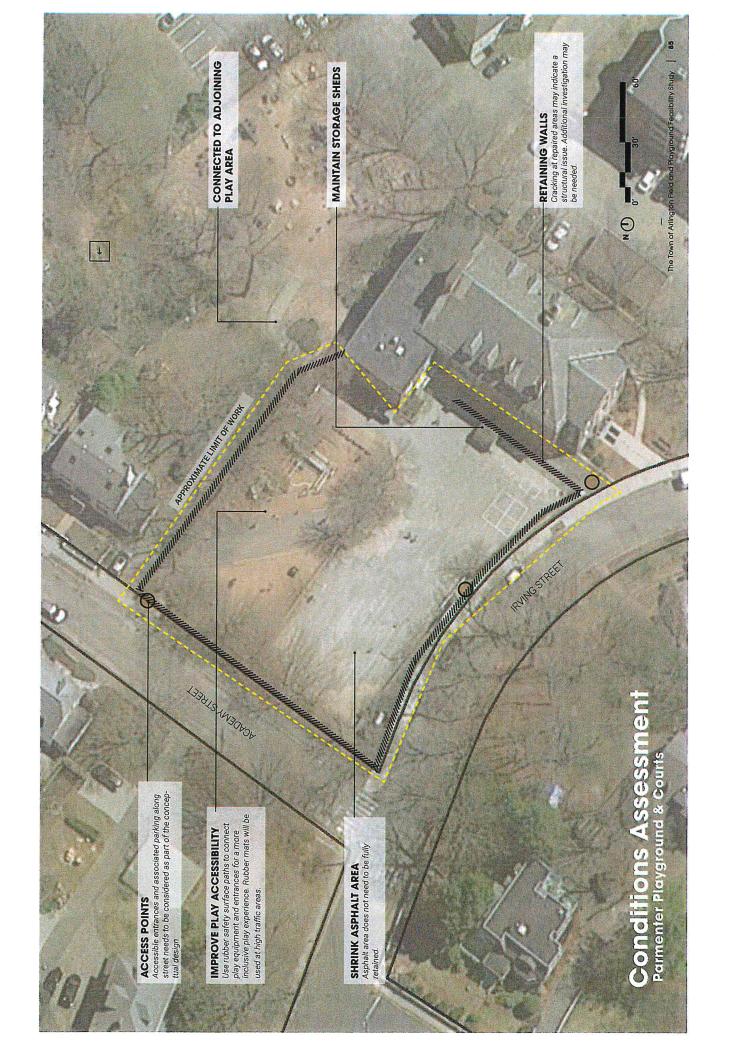

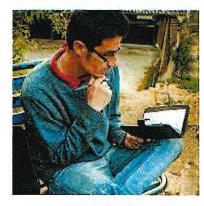





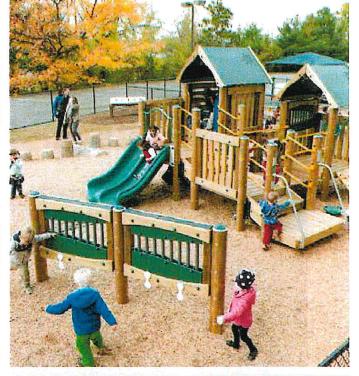











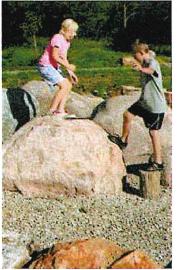

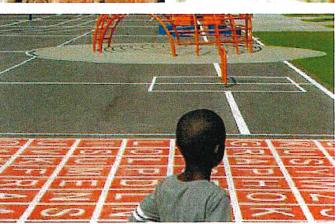

# Precedents Parmenter Playground & Courts



# Conceptual Masterplan

#### Opinion of Probable Project Costs:

Arlington Field and Playground Feasibility Study

DATE



Boston, MA 02114

#### NOTE:

Due to the inflationary and unpredictable construction climate, this opinion of probable costs may not represent the actual cost of construction.

Item#	Item/Remarks	Notes	Total	Unit	Unit Cost	Ct I	Cultural
	ITEMIZED OPINION OF PROBABLE CONSTRUCTION COSTS	Notes	TOTAL	Unit	Unit Cost	Cost	Subtotal
00001	Site Preparation and Demolition / Earthwork	Party Landson	THE CHARLE	ETCH CAP	THE RESTRICTION OF THE PARTY.	SOLUTION SERVICES	\$63,037.50
1	Mobilization		1	ALLOW	\$10,000.00	\$10,000.00	\$63,037.30
2	Remove and Dispose Playground Equipment, Furnishing(s) and Footings	-	1	ALLOW	\$12,000.00	\$10,000.00	
3	Remove and Dispose Safety Surfacing	-	4,625	SF	\$1.00	\$4,625.00	
4	Remove and Dispose pavement (full depth)	<del> </del>	4,850	SF	\$2.25	\$10,912.50	-
5	Wall demolition - wood timber	<b></b>	1	ALLOW	\$12,000.00	\$12,000.00	
6	Common Fill	<u> </u>	300	CY	\$30.00	\$9,000.00	
7	Earthwork		0	ALLOW	\$15,000.00	\$0.00	
8	Construction Fence		100	LF	\$5.00	\$500.00	
9	Tree Protection Fence		500	LF	\$5.00	\$2,500.00	
10	Erosion and Sedimentation Control	<del> </del>	1	ALLOW	\$1,500.00	\$1,500.00	2012
	Subtotal			ALLOW	\$1,500.00	\$63,037.50	
						\$65,057.50	
00002	Park Improvements	THE REAL PROPERTY.	OR PARKS				\$385,063
1	Concrete Paving (entry plaza)	THE REAL PROPERTY.	150	SF	\$11.00	\$1,650.00	2302,003
2	Tot Lot Play Equipment		1	ALLOW	\$125,000.00	\$125,000.00	
3	Natural Play Elements (wood stumps, etc.)		1	ALLOW	\$125,000.00	\$125,000.00	
4	Stone: Boulders & Stacked Stone Slopes		1,275	SF	\$100.00		
5	Paving Repair		1,2/5	ALLOW	\$3,500.00	\$127,500.00 \$3,500.00	
6	Mill and Overlay		9,400	SF	\$3,300.00	\$28,200.00	
7	Bit. Conc. Paving	-	250	SF	\$8.00	\$28,200.00	
8	Pavement markings		1	ALLOW	\$12,000.00	\$12,000.00	
9	12" Depth Wood Fiber Safety Surface		3,100				
10	Rubber Safety Surface		1,000	SF SF	\$10.00 \$30.00	\$31,000.00	
11	Wall Repair		1,000	ALLOW	The state of the s	\$30,000.00	
12	Loam	_			\$2,500.00	\$2,500.00	
13	Loaming & Seeding disturbed areas		115	CY	\$30.00	\$3,450.00	
- 13	Subtotal	_	2,175	SF	\$1.50	\$3,262.50	
	Subtotal					\$385,062.50	
	Subtotal:					-	4
	4% General Conditions						\$448,100
	8% Contractors Overhead and Profit						\$17,924
	6% Price Escalation for FY '24						\$35,848
(	CONSTRUCTION SUBTOTAL:						\$26,886
	CONSTRUCTION SOBTOTAL:						\$528,758
00003	Consulting Costs						
1	Design & Construction Administration				A TOTAL CONTRACTOR	CHECK PARTIES	\$65,000.00
2	Survey		1	ALLOW	\$60,000.00	\$60,000.00	
	Subtotal		1	ALLOW	\$5,000.00	\$5,000.00	
	Subtotui					\$65,000.00	
	DECICAL & CONSTRUCTION SUPPORT						
	DESIGN & CONSTRUCTION SUBTOTAL:						\$593,758
	100/ Constanting Continues						
	10% Construction Contingency					-10	\$52,876
	TOTAL ORINION OF PROPERTY OF THE						
	TOTAL OPINION OF PROBABLE PROJECT COSTS						\$646,634
00004	ALTERNATE #1 : Plantings	Terror and the last		0.00			tar con
1	Deciduous Trees		14	EA	\$1,000.00	\$14,000,00	\$35,600
2	Hardy Groundcover		720			\$14,000.00	. =0
	Subtotal		720	EA	\$30.00	\$21,600.00	-
3,10						\$35,600.00	
00005	ALTERNATE #2 : Site Furnishings	N. S. C. Hall					Ang pan
1	Cafe Tables (w/ conc. pad)	200000000000000000000000000000000000000	4	cr.	\$3,500,00	£14 000 CC	\$35,500
2	Benches (w/ conc. pad)			SF	\$3,500.00	\$14,000.00	
3	Trash Receptacles		6	EA	\$2,500.00	\$15,000.00	
4	Signage		2	EA	\$2,500.00	\$5,000.00	
	Subtotal		1	ALLOW	\$1,500.00	\$1,500.00	
	Pantoral					\$35,500.00	

# Cost Estimate Parmenter Playground & Courts



**Commissioners:** 

Brian J. Connor, Chair Jo Anne Preston, Vice Chair Gaar Talanian, Treasurer Fiorella Badilla Nicholas Mitropoulos Executive Director
Jack Nagle

Tel.:

(781) 646-3400

Fax:

(781) 643-6923

April 14, 2022

Ms. Mallory Sullivan
Department of Planning and Community Development
Town of Arlington
730 Mass Ave. Annex
Arlington, MA 02476

RE: Community Development Block Grant (CDBG) Application for Hauser Building

Dear Ms. Sullivan,

This letter is the Arlington Housing Authority's request for consideration for off cycle CDBG funding. We are requesting \$350,000.00 to help fund our Fire Alarm System Upgrade project at the Hauser Building located at 37 Drake Road, Arlington, MA 02476. We currently have \$501,606.50 committed to this project in DHCD Formula Funding. When this project was previously bid the low bidder came in at \$836,900.00. We decided to reject the low bidder due to the Arlington Housing Authority not having sufficient funding for this project. CDBG off cycle funding will allow the Arlington Housing Authority to rebid the project without reducing the scope. It will also provide the AHA the ability to bid the project in accordance with Davis Bacon Wage Determinations and other applicable requirements associated with Federal funding sources like CDBG. The reason I have requested \$350,000.00 rather than the exact figure is anticipated cost increases related to Davis Bacon Wage Determinations and others.

I have enclosed with this letter the drawings and specifications for this project for your reference. They will showcase important details related to this project including that this work will take place in all 144 units at the Hauser Building. Our plan is to rebid this project as soon as possible. This will ensure that the work will be able to be completed in State/Town Fiscal Year 2023.

We appreciate the continued partnership between the Town of Arlington and the AHA in looking for solutions to modernize the AHA's developments. We hope you consider the Arlington Housing Authority's proposal as a sustainable, cost-effective and good use of CDBG funds.


If you should have any questions, please do not hesitate to contact me at <u>inagle@arlingtonhousing.org</u> or 781-646-3400 x12.

Sincerely,

Jack Nagle

Executive Director

# DHCD PROJECT # 010102 ARLINGTON HOUSING AUTHORITY FIRE ALARM SYSTEM UPGRADES 37 DRAKE RD DEVELOPMENT, 667-4 HAUSER BUILDING

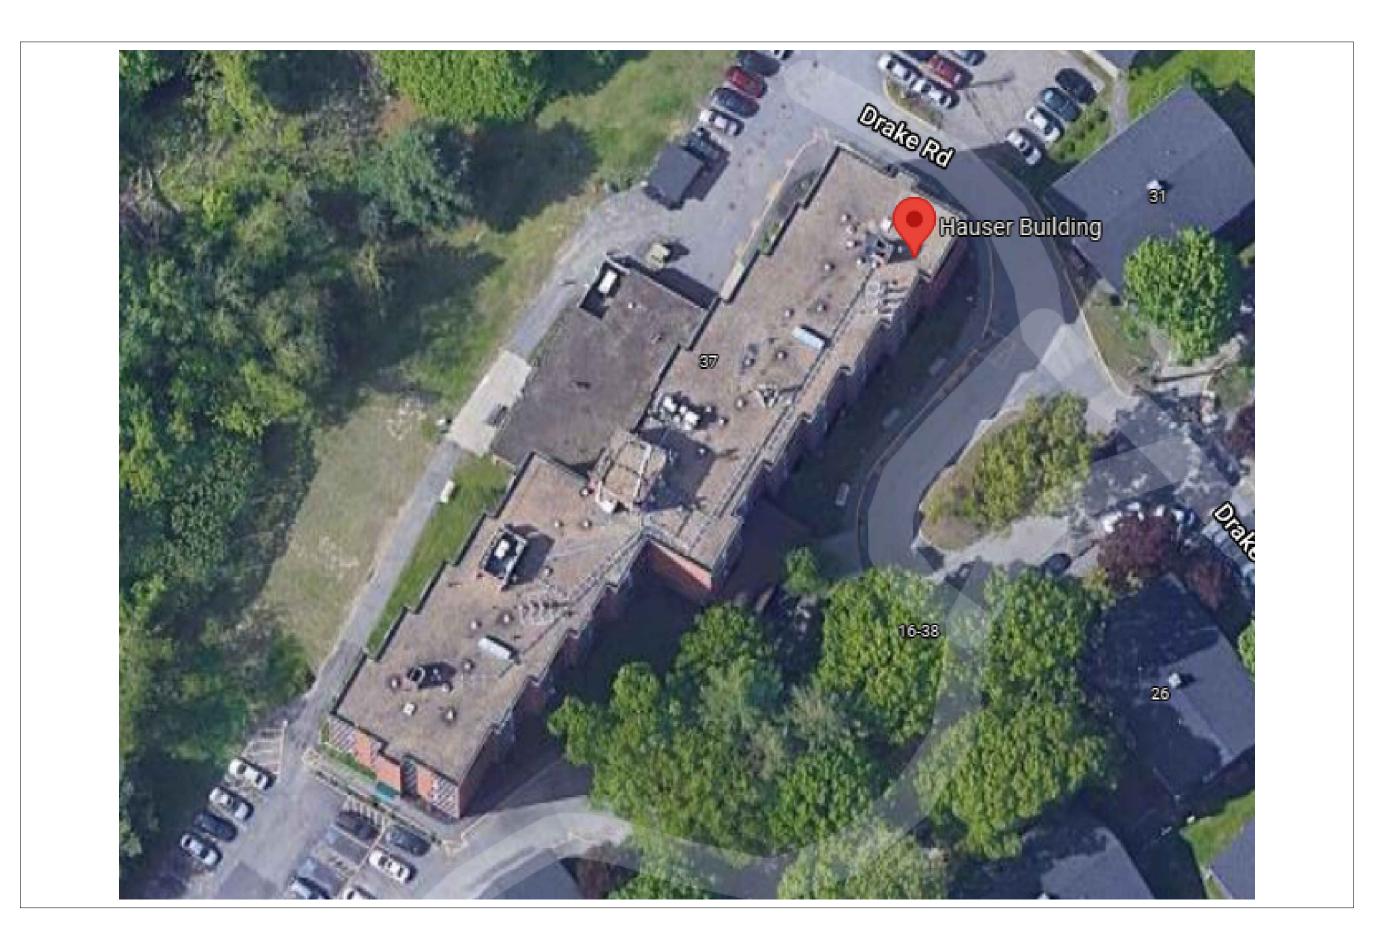

# Drawing List


37 DRAKE RD 667-4

FA-0.0	FIRE ALARM LEGEND, NOTES, RISER AND DETAILS
FA-0.1	FIRST FLOOR DEMOLITION PLANS
FA-0.2	SECOND FLOOR DEMOLITION PLANS
FA-0.3	THIRD THROUGH SEVENTH FLOOR DEMOLITION PLANS
FA-1.0	FIRST FLOOR FIRE ALARM PLANS
FA-1.1	SECOND FLOOR FIRE ALARM PLANS
FA-1.2	THIRD THROUGH SEVENTH FLOOR FIRE ALARM PLANS
FA-2.0	TYPICAL UNIT FIRE ALARM PLANS
FP-1	FIRE PROTECTION LEGEND, NOTES, RISER AND DETAILS
FP-2	1ST FLOOR FIRE PROTECTION PLANS
FP-3	2ND FLOOR FIRE PROTECTION PLANS
FP-4	3RD THROUGH 7TH FLOOR FIRE PROTECTION PLANS

# Project Engineer


MacRitchie Engineering, Inc. 197 Quincy Avenue Braintree, MA 02184 (781) 848-4464


NOVEMBER 18, 2021

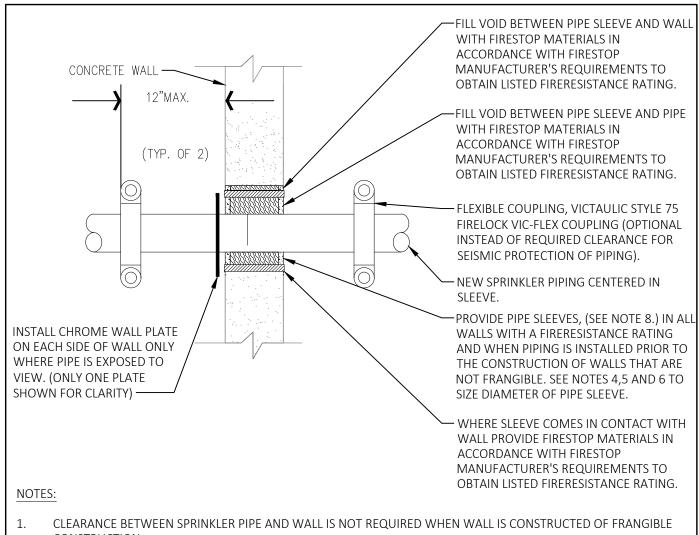

- FIRESTOP SYSTEMS ARE NOT REQUIRED FOR PENETRATIONS THROUGH FLOORS AND WALLS WHICH DO NOT HAVE A FIRE RESISTANCE RATING. REFER TO ARCHITECTURAL DRAWINGS FOR LOCATION OF WALLS WHICH HAVE A FIRE-RESISTANCE RATING. ALL VOIDS IN AND AROUND PIPE SLEEVES IN NON- RATED WALLS SHALL BE FILLED WITH MINERAL WOOL TO PREVENT THE MOVEMENT OF SMOKE. REFER TO DIVISION 07 SECTION "PENETRATION FIREPROOFING".
- THIS CONTRACTOR SHALL BE RESPONSIBLE FOR PROVIDING CLEARANCE AROUND ALL PIPING FOR SEISMIC PROTECTION AND PIPE SLEEVES WITH FIRESTOP MATERIALS.
- PIPE SLEEVES SHALL HAVE A NOMINAL DIAMETER 2" LARGER THAN THE NOMINAL DIAMETER OF THE SPRINKLER PIPE FOR PIPE SIZES 1" THROUGH 3".
- PIPE SLEEVES SHALL HAVE A NOMINAL DIAMETER 4" LARGER THAN THE NOMINAL DIAMETER OF THE SPRINKLER PIPE FOR PIPE SIZES 4" AND LARGER.
- FLEXIBLE COUPLINGS ARE ACCEPTABLE ON EACH SIDE OF WALL. THE NOMINAL DIAMETER OF THE SLEEVE SHALL BE ONE PIPE SIZE LARGER THAN THE DIAMETER OF THE SPRINKLER PIPE WHEN FLEXIBLE COUPLINGS ARE USED.
- ALL FIRESTOPPING BY DIVISION 07 SECTION 078413 "FIRESTOPPING"
- SLEEVES THROUGH LOAD BEARING WALLS SHALL BE SCHEDULE 40 BLACK STEEL PIPE. OTHER PIPE SLEEVE MATERIALS ARE ACCEPTABLE PROVIDED THEY HAVE BEEN TESTED AS PART OF THE FIRE RATED ASSEMBLY. ALL PIPE SLEEVES THROUGH EXTERIOR WALLS SHALL BE GALVANIZED STEEL.

## WALL PENETRATION DETAIL NOT TO SCALE

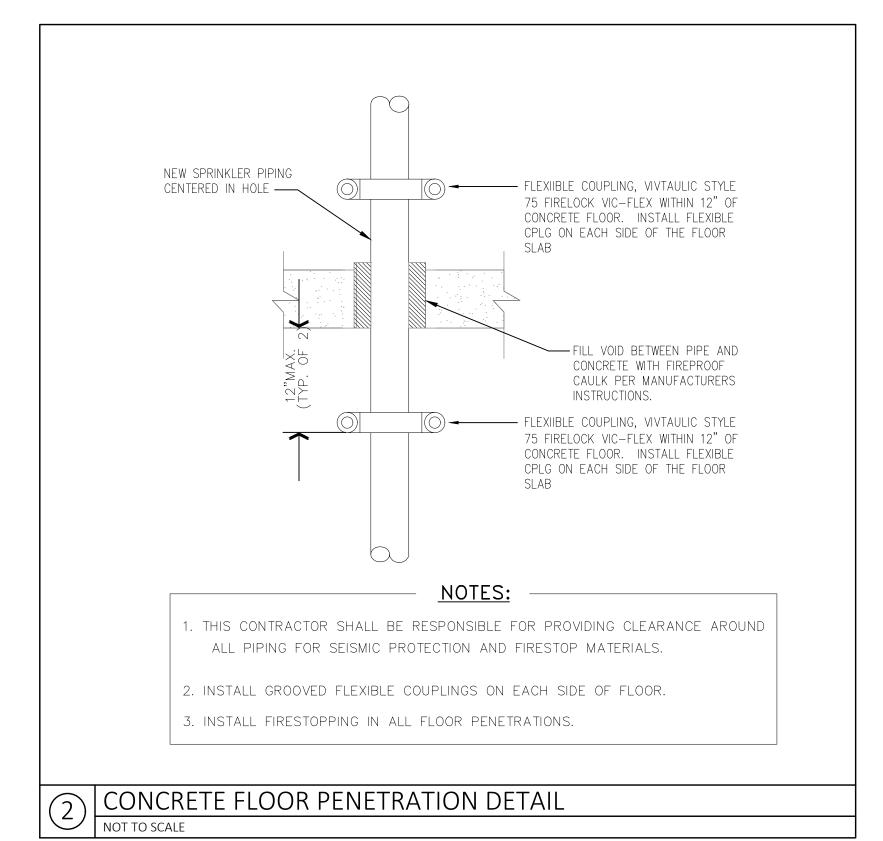

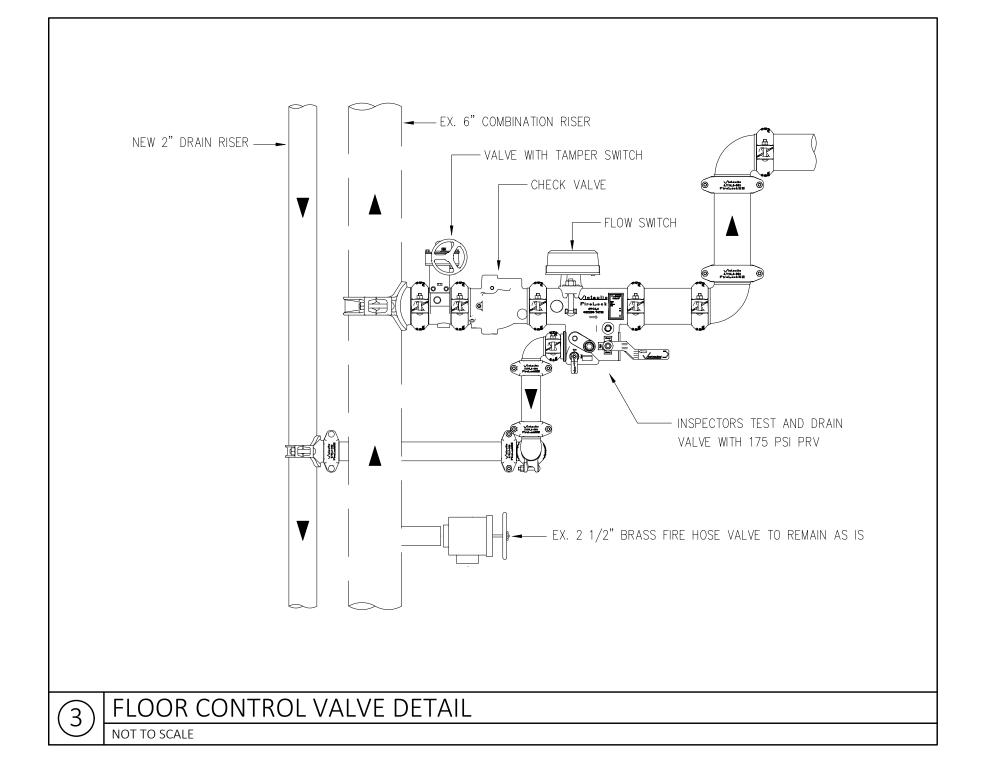

## SPRINKLER SYSTEM DESIGN NARRATIVE

INSTALL A DRAIN RISER IN EACH STAIR TOWER AS INDICATED ON THE DRAWINGS. SEE DESIGN NOTES BELOW FOR FURTHER INSTALLATION INFORMATION. THE NEW SYSTEM SHALL BE INSTALLED PER NFPA 13 2013 AND FPA 14, 2013 EDITION & THE STATE BUILDING & FIRE CODES.

#### CODES AND AUTHORITIES:

TOWN OF ARLINGTON FIRE DEPARTMENT.

#### HAZARD CLASSIFICATION:

LIGHT HAZARD - 0.10 GPM/SQ. FT. OVER 1500 SQ. FT. - OFFICES, RESTROOM, SEATING AREAS,

ORDINARY HAZARD - GROUP 1 - 0.15 GPM OVER 1500 SQ. FT. - MECHANICAL ROOMS, KITCHEN AREA AND JANITOR'S CLOSET'S.

ORDINARY HAZARD - GROUP 2 - 0.20 GPM OVER 1500 SQ. FT. - STORAGE AREAS.

#### COVERAGE PER SPRINKLER:

225 SQ. FT. - STANDARD COVERAGE MAXIMUM - LIGHT HAZARD. 130 SQ. FT. - STANDARD COVERAGE MAXIMUM - ORD. HAZARD.

MINIMUM PRESSURES AND FLOWS PER SPRINKLER SHALL BE BASED ON MANUFACTURES PUBLISHED CRITERIA.

#### INSTALLATION REQUIREMENTS:

- 1. ANY CONFLICTS FOUND BY THE CONTRACTOR SHALL BE BROUGHT TO THE ARCHITECTS ATTENTION, DO NOT PROCEED WITH WORK IN AREA OF CONFLICT UNTIL A RESOLUTION HAS BEEN AGREED UPON BETWEEN ALL PARTIES INVOLVED AND NOTIFICATION HAS BEEN RECEIVED FROM ARCHITECT.
- 2. THE CONTRACTOR SHALL RECEIVE WRITTEN APPROVAL AND STAMPED DRAWINGS FROM THE FIRE MARSHAL'S OFFICE BEFORE ORDERING AND INSTALLING ANY PIPING.

## SPRINKLER SYSTEM GENERAL NOTES

- 1. THE CONTRACTOR SHALL REVIEW ALL CONSTRUCTION DOCUMENTS FOR THIS PROJECT PRIOR TO SUBMITTAL OF PROPOSAL AND THOROUGHLY FAMILIARIZE THEMSELVES WITH CONDITIONS THAT WILL AFFECT THE PERFORMANCE OF THE WORK. FAILURE TO DO SO WILL NOT ENTITLE THEM TO ANY ADDITIONAL COMPENSATION FOR PROVIDING A COMPLETE AND APPROVED SPRINKLER SYSTEM.
- 2. COORDINATE WORK WITH ALL TRADES PRIOR TO INSTALLATION. COORDINATE NEW SPRINKLER LOCATIONS WITH ALL LIGHTS, DUCTWORK, DIFFUSERS & REGISTERS, STRUCTURAL BEAMS AND ELECTRICAL EQUIPMENT. ADJUST LOCATIONS AS REQUIRED TO COMPLY WITH THE OBSTRUCTIONS RULES OF NFPA 13.
- 3. THE DRAWINGS SHOW PREFERRED HEAD AND PIPE LOCATIONS IN AREAS DEEMED CRITICAL FOR COORDINATION. THE NUMBER AND LOCATION OF HEADS, AND THE ROUTING AND SIZE OF PIPES IS NOT INTENDED TO FURNISH A FINISHED LAYOUT. THE CONTRACTOR SHALL PROVIDE COMPLETE SPRINKLER COVERAGE FOR ALL AREAS OF THE BUILDING IN ACCORDANCE WITH THE PERFORMANCE SPECIFICATION OF THE PROJECT MANUAL. ALL PIPE AND HEAD LOCATIONS SHALL BE COORDINATED BY THIS CONTRACTOR WITH THE WORK OF OTHER TRADES.
- 3. SUBMIT WORKING DRAWINGS TO THE LOCAL FIRE MARSHAL FOR REVIEW AND APPROVAL. INCORPORATE ALL COMMENTS.

## FIRE PROTECTION LEGEND

THE FOLLOWING DESIGNATIONS SHALL APPLY TO ALL FIRE PROTECTION SYMBOLS; UNLESS OTHERWISE NOTED:

N = NEW.DN = DOWN.

FCVA = FLOOR CONTROL VALVE ASSEMBLY.

SPRINKLER PIPING.

SPRINKLER DRAIN PIPING PIPE RISER UP (& DOWN)

——— PIPE DROP

PIPE TEE DROP

——— PIPE DROP & RUN

—U— PIPE TEE OFF TOP

**ENGINEERING INCORPORATED** 

197 Quincy Avenue, Braintree, MA 02184 Tel. (781) 848-4464 Fax (781) 848-2613 www.macritchie.net

ENGINEER'S STAMP:

PROJECT TITLE: ARLINGTON HOUSING AUTHORITY HAUSER BUILDING

37 DRAKE RD ARLINGTON, MA 02476

FIRE ALARM UPGRADES

DRAWING TITLE: FIRE PROTECTION NARRATIVE, LEGEND, NOTES AND DETAILS


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2021-028.00


PROJECT NO:

FP-1



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ENGINEER'S STAMP:

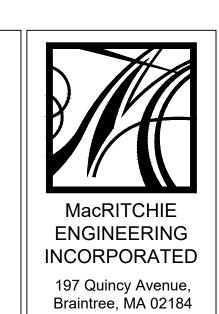PROJECT TITLE:

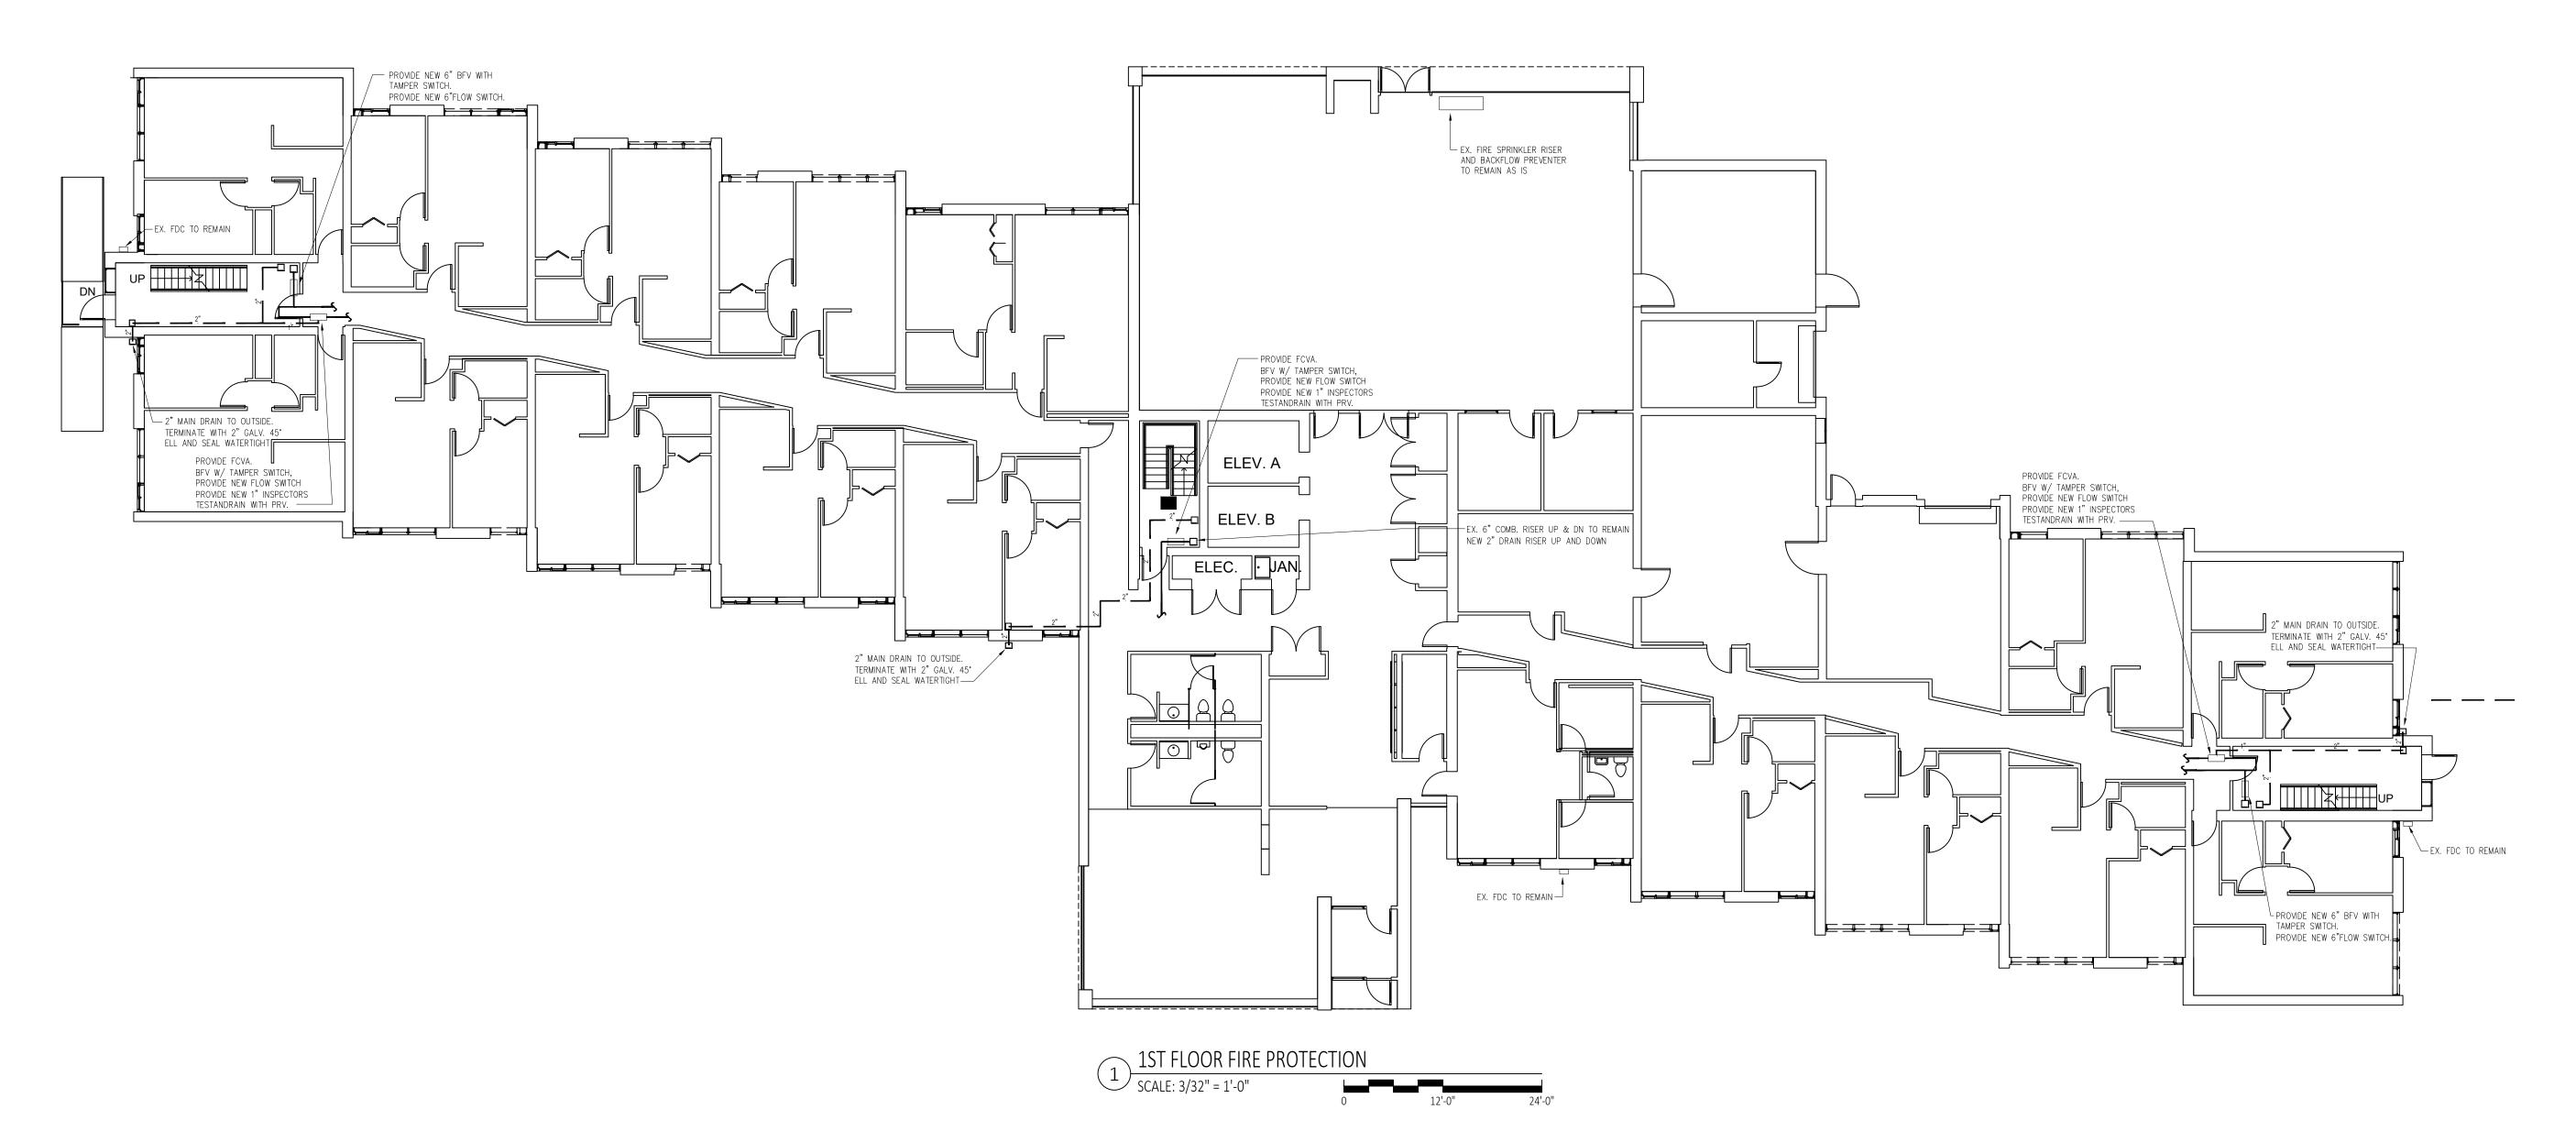ARLINGTON HOUSING
AUTHORITY
HAUSER BUILDING
FIRE ALARM UPGRADES

37 DRAKE RD ARLINGTON, MA 02476

DRAWING TITLE:

1ST FLOOR
FIRE PROTECTION
FLOOR PLAN

DRAWING REVISIONS:

DATE DESCRIPTION

SCALE:

AS NOTED

DRAWN BY:

CHECKED BY:

BM

DATE:


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FILENAME: 2021-028.00 PROJECT NO:


FP-2

SHEET NUMBER



Tel. (781) 848-4464

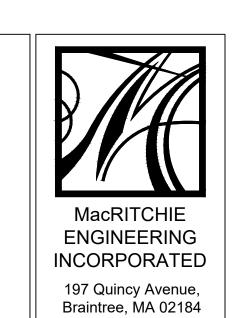Fax (781) 848-2613 www.macritchie.net

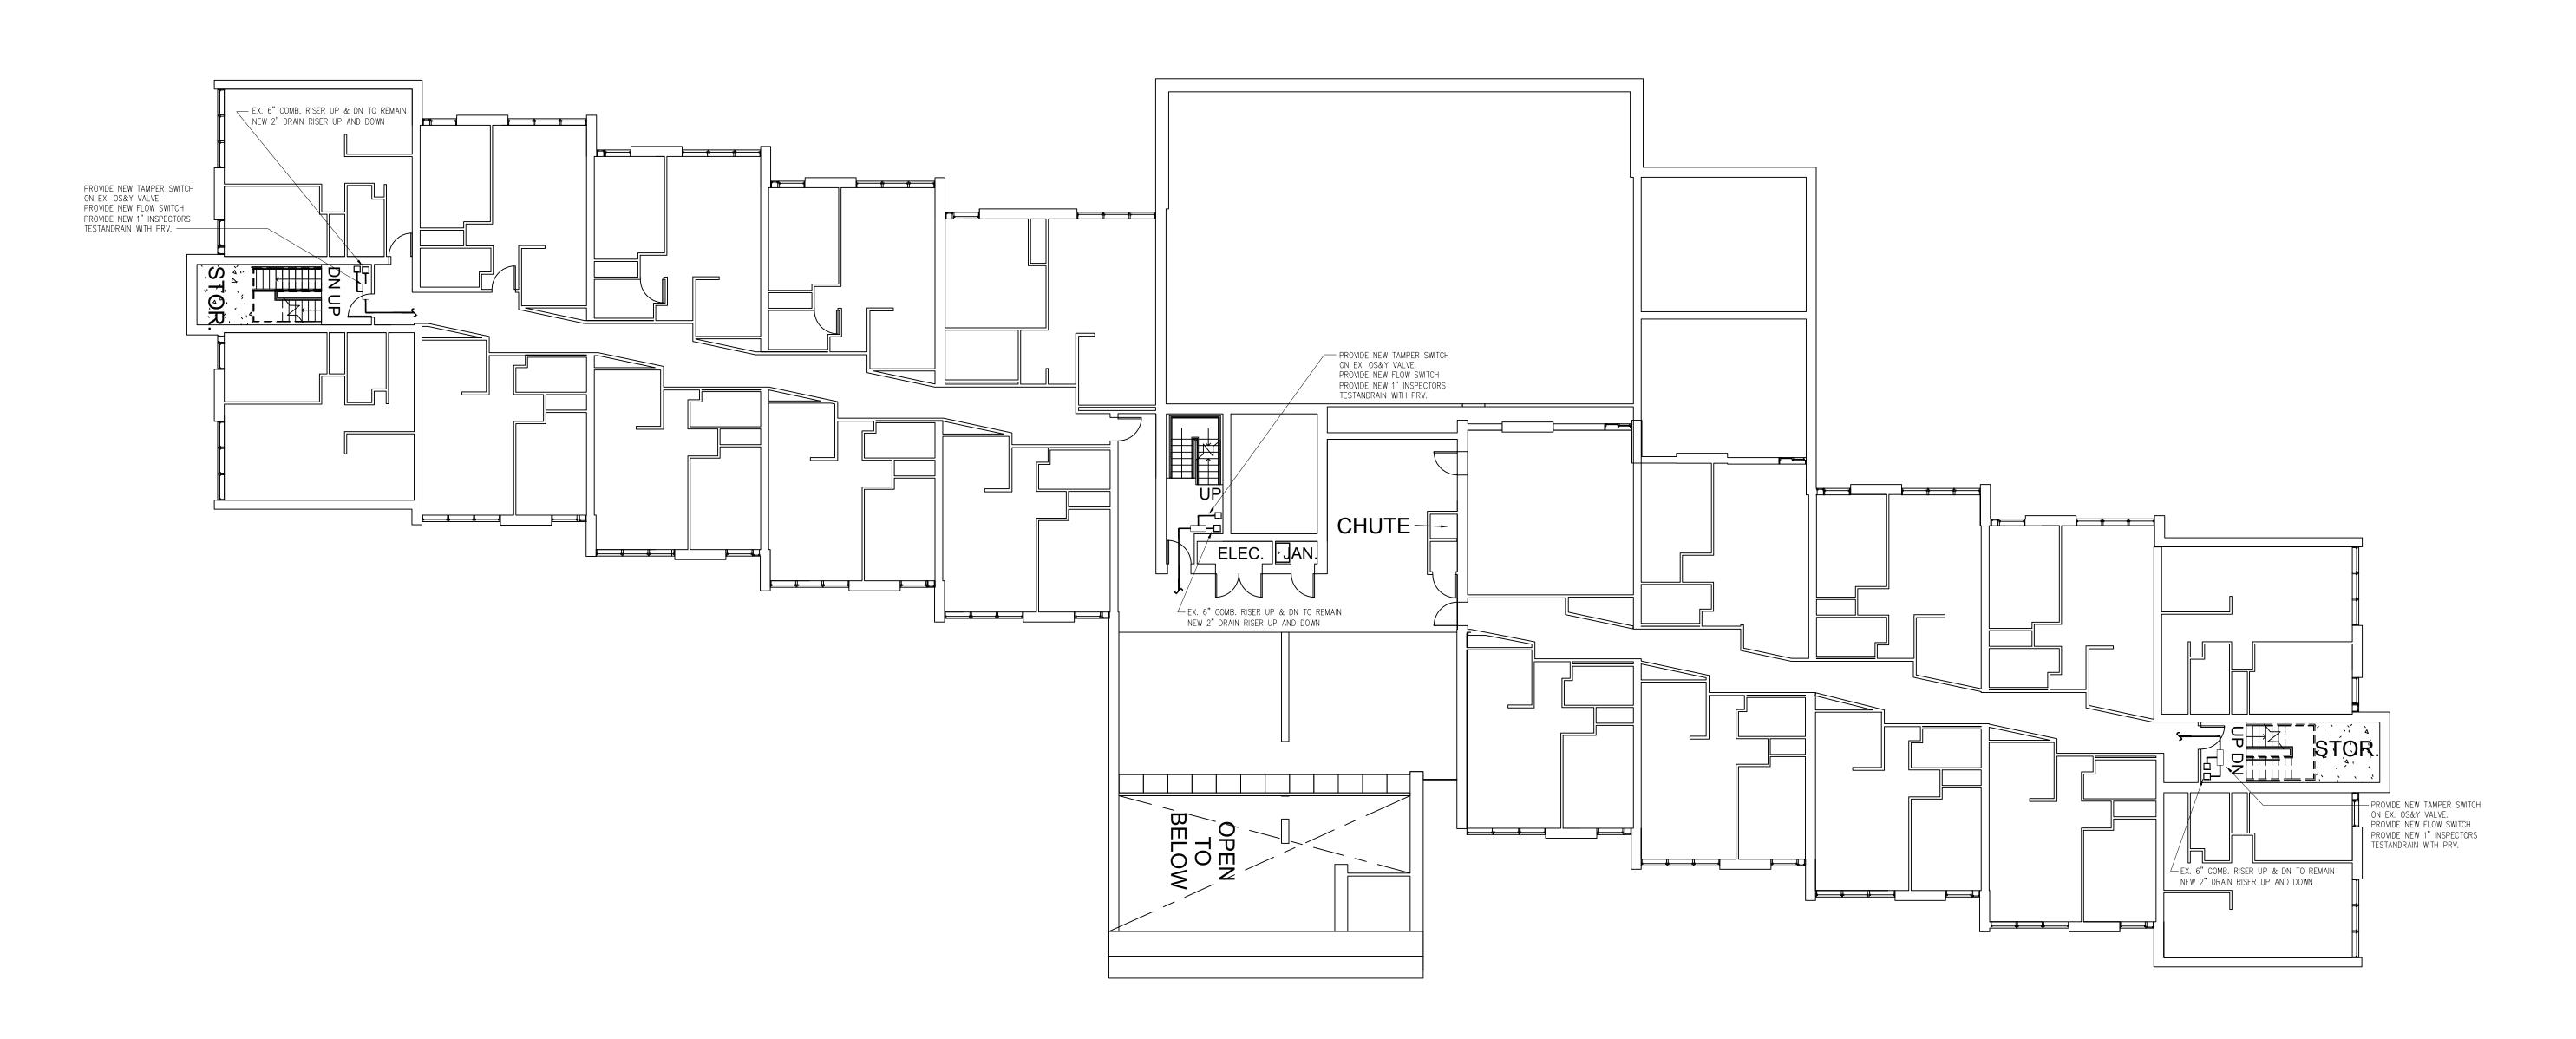



ENGINEER'S STAMP:

PROJECT TITLE:
ARLINGTON HOUSING
AUTHORITY
HAUSER BUILDING
FIRE ALARM UPGRADES

37 DRAKE RD ARLINGTON, MA 02476

DRAWING TITLE:

2ND FLOOR
FIRE PROTECTION
FLOOR PLAN

DRAWING REVISIONS:

DATE DESCRIPTION

SCALE: AS NOTED

DCE

DRAWN BY:

CHECKED BY:

DATE:

11/18/2021

FILENAME:


FILENAME:

2021-028.00
PROJECT NO:

FP-3

SHEET NUMBER



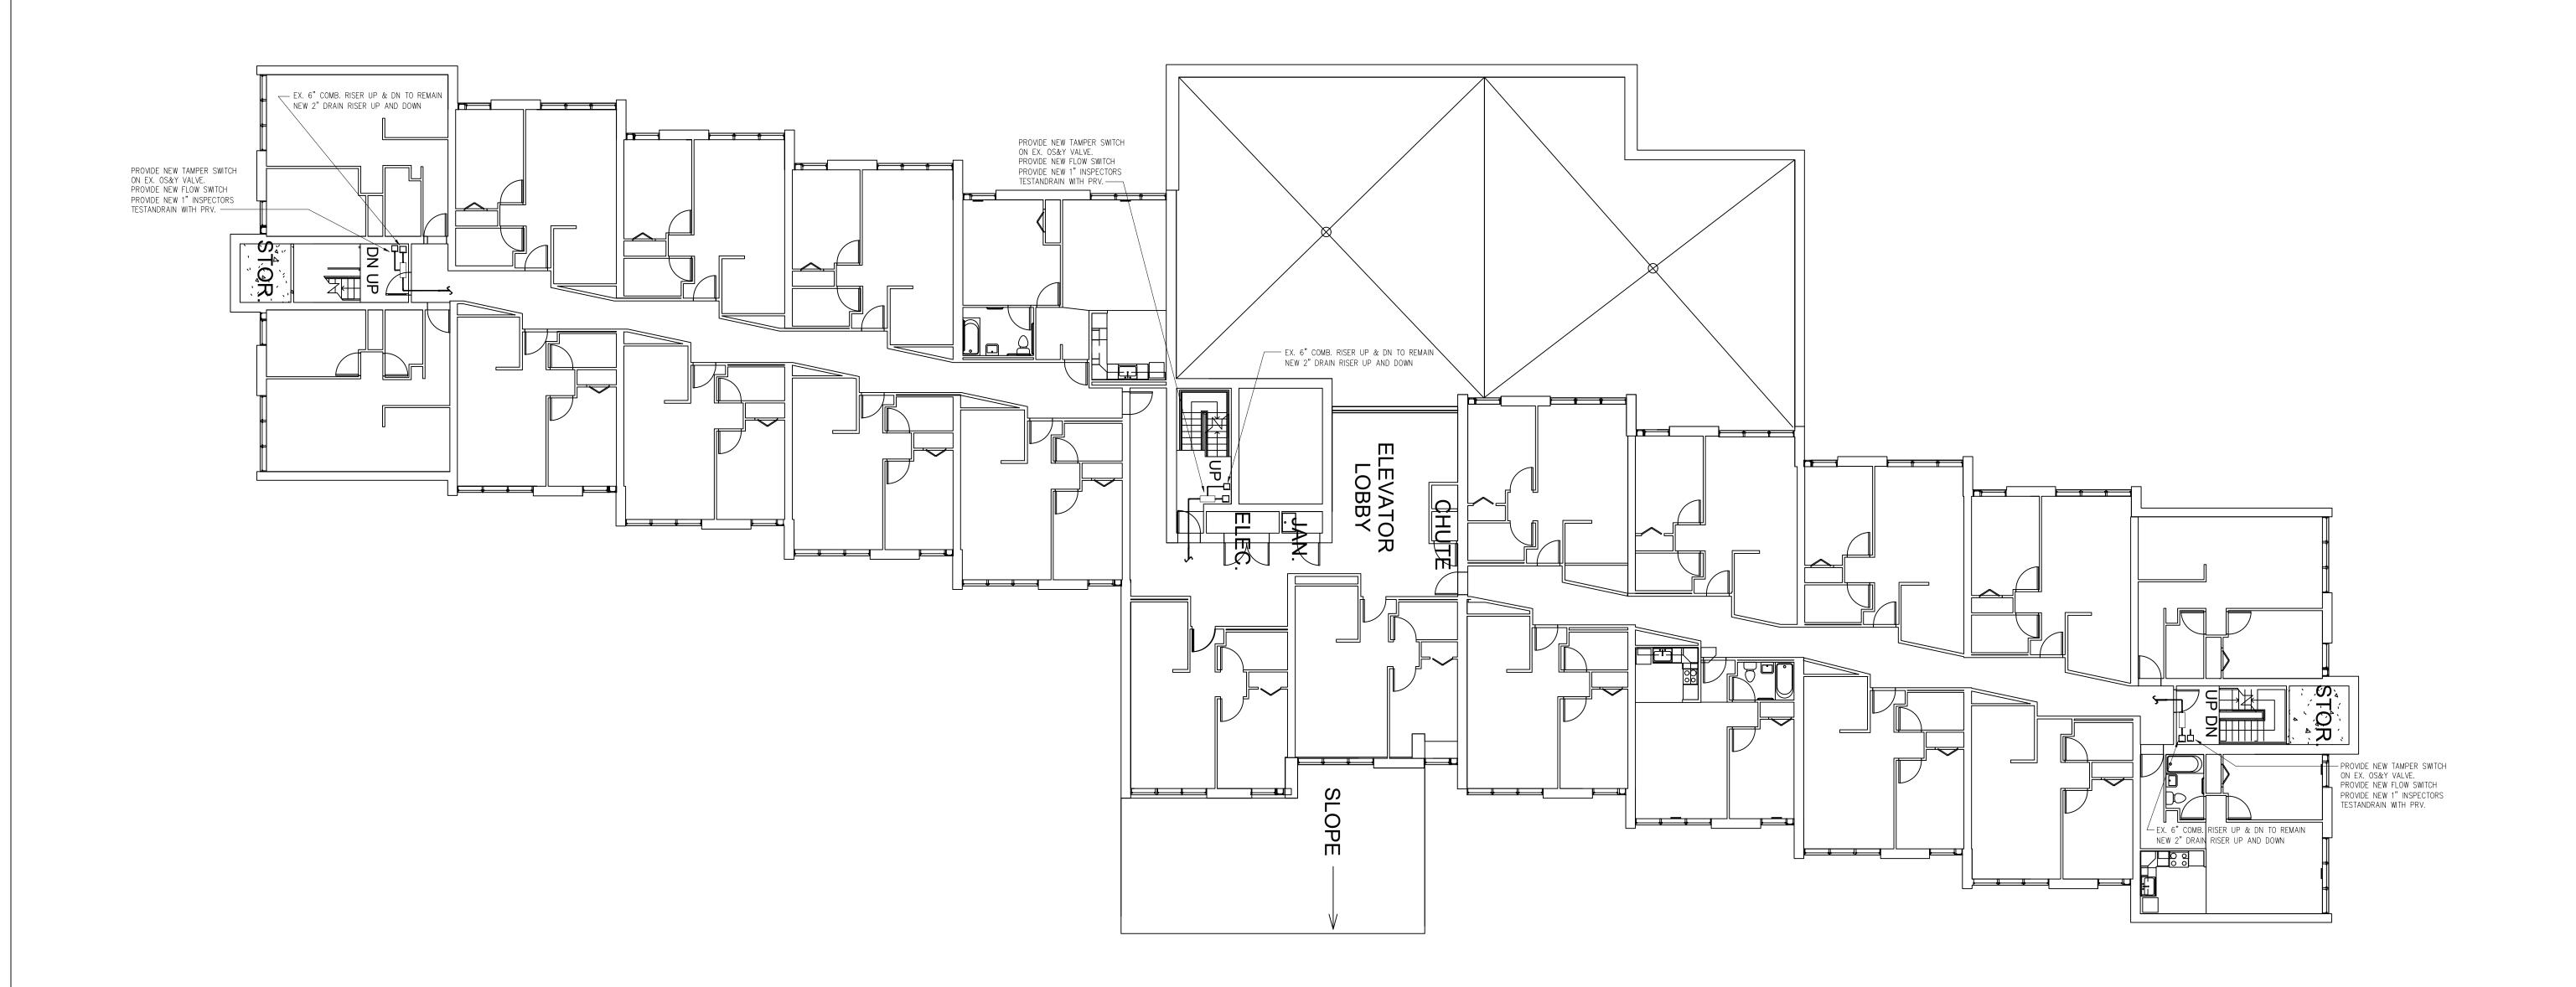

3RD THRU 7TH FLOOR FIRE PROTECTION

SCALE: 3/32" = 1'-0"

ENGINEER'S STAMP:

PROJECT TITLE:

ARLINGTON HOUSING
AUTHORITY
HAUSER BUILDING
FIRE ALARM UPGRADES

37 DRAKE RD ARLINGTON, MA 02476

DRAWING TITLE:

3RD THRU 7TH FLOOR
FIRE PROTECTION
FLOOR PLANS

DRAWING REVISIONS:

DATE DESCRIPTION

SCALE: AS NOTED

DRAWN BY: DCE

CHECKED BY: BM

DATE: 11/18/2021

FILENAME: 2021-028.00 PROJECT NO:

FP-4

# FIRE ALARM NOTES:

- 1. COORDINATE EXACT MTG. LOCATION AND HEIGHT WITH ARCHITECTURAL DRAWINGS.
- 2. ALL COMPONENTS SHOWN ON THE RISER DIAGRAMS, BUT NOT ON THE PLAN OR VICE VERSA, SHALL BE INCLUDED AS IF SHOWN ON BOTH.
- 3. ALL SLC, IDC, AND NAC WIRING SHALL BE CLASS 'A', WIRED PER MANUFACTURER'S SPECIFICATIONS. WIRING SHALL BE PER NFPA 70 AND PER NFPA 72. WIRING SHALL BE RUN CONCEALED OR IN EMT WHERE EXPOSED.
- 4. ALL WIRING SHALL BE RUN CONCEALED UNLESS SPECIFIED OTHERWISE. EXPOSED WIRING SHALL BE IN CONDUIT AND RUN FLUSH TO THE STRUCTURE IN A NEAT RECTILINEAR MANNER, ALWAYS PERPENDICULAR TO WALLS.
- 5. ALL RACEWAYS RUNNING THROUGH BUILDING EXPANSION JOINTS SHALL BE EQUIPPED WITH EXPANSION FITTINGS. COORDINATE WITH ARCHITECTURAL AND STRUCTURAL PLANS.
- 6. ALL RACEWAYS RUNNING THROUGH BUILDING FIRE WALLS OR SMOKE BARRIERS SHALL BE SEALED AROUND WITH APPROVED FIRE SEALANT, BY THE FIRE ALARM SYSTEM INSTALLER. COORDINATE WITH ARCHITECTURAL PLANS.
- 7. SYSTEM RECORD DOCUMENTS CABINET SHALL BE LOCATED SEMI-FLUSH IN WALL BELOW FIRE ALARM SYSTEM REMOTE ANNUNCIATOR IN MAIN ENTRY VESTIBULE. COORDINATE EXACT LOCATION AND MOUNTING WITH ARCHITECT.
- 8. COORDINATE FIRE ALARM SYSTEM REQUIREMENTS WITH FIRE PROTECTION OFFICER OF LOCAL FIRE DEPARTMENT PRIOR TO SUBMITTING SHOP DRAWINGS TO ARCHITECT FOR APPROVAL.
- 9. PROVIDE A MINIMUM OF 20% SPARE CAPACITY IN THE NOTIFICATION APPLIANCE CIRCUITRY (INCLUDING BATTERY CAPACITY) FOR ADDITIONAL NOTIFICATION APPLIANCES WHICH MAY BE REQUIRED FOR FUTURE HEARING IMPAIRED EMPLOYEES OR TENANTS (SEE NFPA 72 907.5.2.3.2).
- 10. LOCATIONS OF DEVICES ARE SHOWN BASED UPON CODE REQUIRED CALCULATIONS PERFORMED BY THE ELECTRICAL ENGINEER. DEVICES SHALL NOT BE RELOCATED WITHOUT WRITTEN PERMISSION FROM THE ENGINEER OF RECORD. SEND ALL PROPOSED LOCATION CHANGES IN WRITING, ALL AT THE SAME TIME, FOR APPROVAL IN THE FORM OF SKETCHES WITH DIMENSIONS. VERBAL REQUESTS SHALL NOT BE PERMITTED FOR CHANGING THE LOCATIONS OF LIFE SAFETY
- DEVICES AND EQUIPMENT.

  11. MANUAL (PULL) STATIONS SHALL BE INSTALLED WITHIN 5'-0" OF THE PULL SIDE OF THE EGRESS DOOR THAT THEY SERVE. COORDINATE EXACT LOCATION WITH ARCHITECT.
- 12. ALL SMOKE DETECTORS SHALL BE INSTALLED AS SHOWN, PER THE MANUFACTURER'S RECOMMENDATIONS AND SHALL BE KEPT A MINIMUM OF 36" FROM ANY SUPPLY OR RETURN DIFFUSER, INCLUDING EXHAUST GRILLS AND/OR DIFFUSERS.
- 13. THE EXISTING FIRE ALARM SYSTEM WILL REMAIN FULLY FUNCTIONAL DURING THE DURATION OF CONSTRUCTION UNTIL THE NEW FIRE ALARM SYSTEM IS COMPLETED, TESTED, AND FULLY FUNCTIONAL.

# FIRE ALARM SYMBOL LEGEND


SYMBOL DESCRIPTION

- F ADDRESSABLE MANUAL PULL STATION. PROVIDE WITH "STI" STOPPER II COVERS OR APPROVED EQUAL.
- ADDRESSABLE PHOTOELECTRIC SMOKE DETECTOR.
- FS PROVIDE WIRING AND CONNECTION TO SPRINKLER SYSTEM FLOW SWITCH. SWITCH PROVIDED BY F.P. CONTRACTOR.
- TS PROVIDE WIRING AND CONNECTION TO SPRINKLER SYSTEM TAMPER SWITCH. SWITCH PROVIDED BY F.P. CONTRACTOR.
- PS PROVIDE WIRING AND CONNECTION TO SPRINKLER SYSTEM PRESSURE SWITCH. SWITCH PROVIDED BY F.P. CONTRACTOR.
- M ADDRESSABLE MONITOR MODULE.
- TILF LOW FREQUENCY SOUNDER BASE.
- 15 WALL MOUNTED VISUAL ONLY ALARM SIGNAL.
- 30 V WALL MOUNTED SPEAKER STROBE.
- XRTS

  KEYED DUCT SMOKE DETECTOR TEST SWITCH WITH REMOTE ALARM INDICATOR.
  LOCATE PER LOCAL FIRE DEPARTMENT
- K FIRE DEPARTMENT KEY VAULT.

FIRE ALARM SYSTEM CONTROL UNIT.

- NAC FIRE ALARM NAC EXTENDER WITH BATTERIES UNIT.
- XRI REMOTE INDICATOR.
- PROVIDE 24VDC CONNECTION TO ELECTRIC WATER
  FLOW BELL (BY FP CONTRACTOR) FROM INDEPENDENT
  POWER SUPPLY. TWO POLE FLOW SWITCH BY FP
  CONTRACTOR AS WELL. COORDINATE LOCATION W/
  SPRINKLER CONTRACTOR AND LOCAL FIRE DEPARTMENT
- FIRE ALARM SYSTEM REMOTE ANNUNCIATOR.
- WEATHERPROOF EXTERIOR FIRE ALARM STROBE LIGHT.
  COLOR DESIGNATION:
  "R" INDICATES RED
  "W" INDICATES WHITE
  - FIRE ALARM SYSTEM RECORD DOCUMENTS CABINET PROVIDE SPACE AGE ELECTRONICS # SSU00689.
- x1 = QUANTITIES

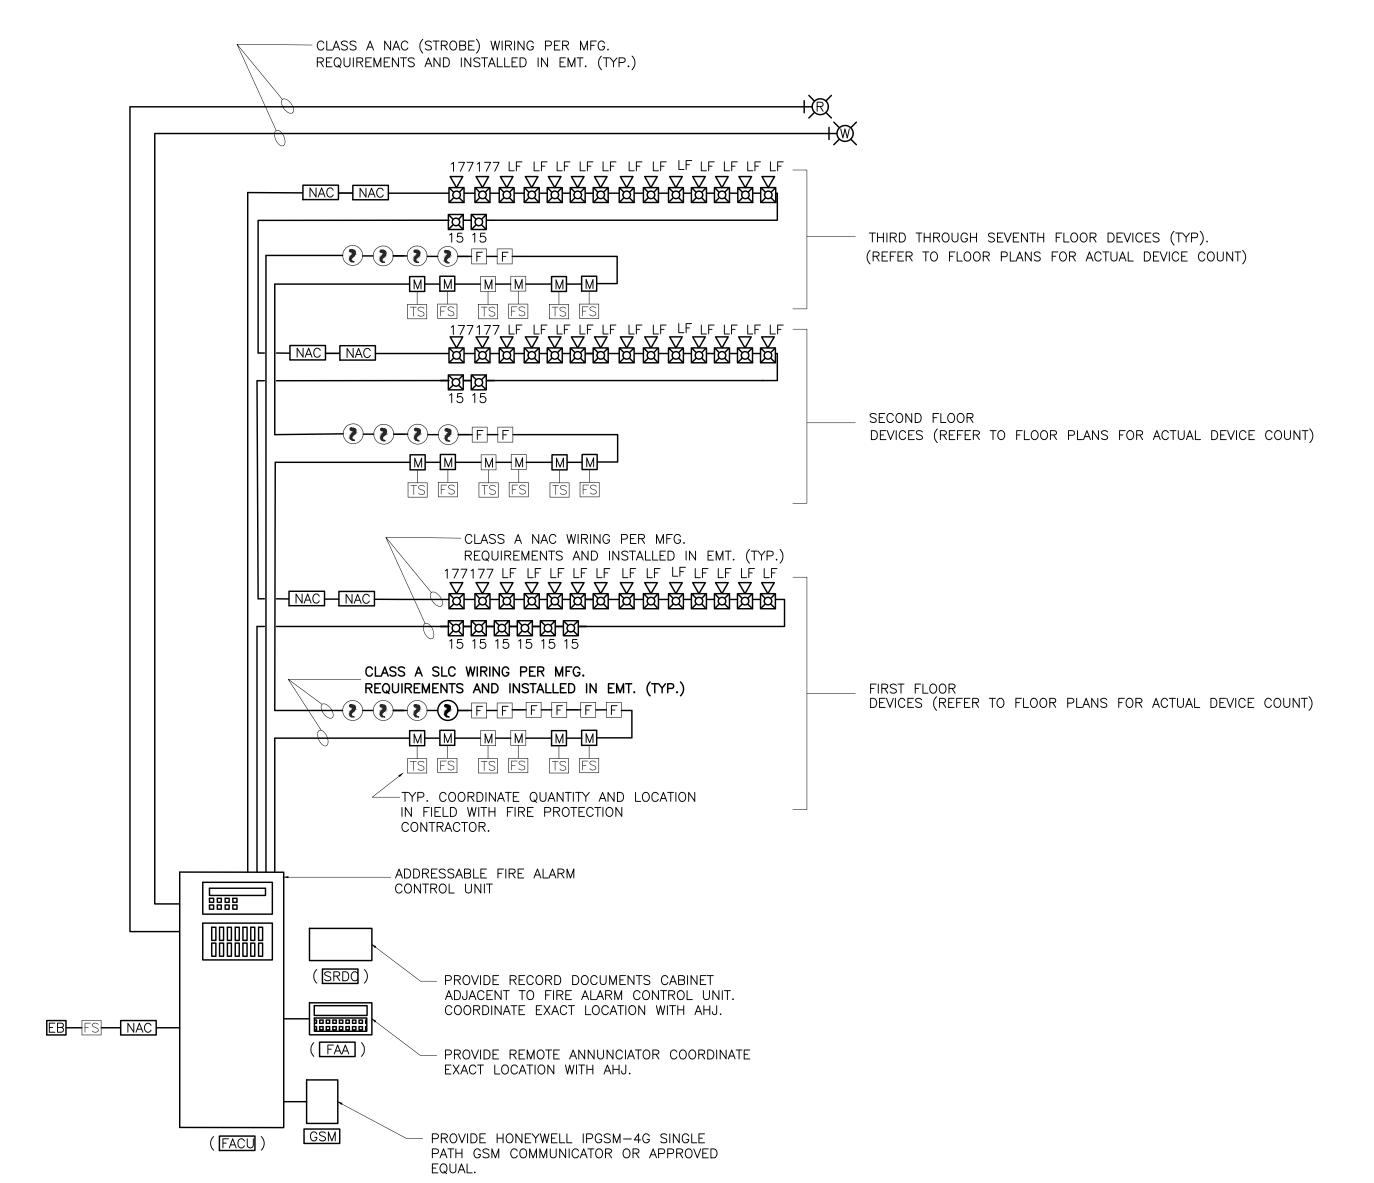





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ENGINEER'S STAMP:

ARLINGTON HOUSING

FIRE ALARM UPGRADES

ARLINGTON, MA 02476

HAUSER BUILDING

PROJECT TITLE:

AUTHORITY

37 DRAKE RD

DRAWING TITLE:
FIRE ALARM LEGEND,
NOTES, RISER AND
DETAILS

DRAWING REVISIONS:

DATE DESCRIPTION

SCALE: AS NOTED

DRAWN BY: HG

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11/18/2021

2021-028.00

SHEET NUMBER

PROJECT NO:





ENGINEER'S STAMP:

PROJECT TITLE: ARLINGTON HOUSING
AUTHORITY
HAUSER BUILDING
FIRE ALARM UPGRADES

37 DRAKE RD ARLINGTON, MA 02476

DRAWING TITLE: FIRST FLOOR DEMOLITION PLANS

DRAWING REVISIONS: DATE DESCRIPTION

> AS NOTED HG

2021-028.00

FA-0.1

FIRST FLOOR DEMOLITION PLAN

SCALE: 3/32" = 1'-0"

DEMOLITION NOTES: 1. DEMOLISH ALL FIRE ALARM DEVICES WITH IN TENANT UNITS.





SECOND FLOOR DEMOLITION PLAN

SCALE: 3/32" = 1'-0"

DEMOLITION NOTES:

1. DEMOLISH ALL FIRE ALARM DEVICES WITH IN TENANT UNITS.

ENGINEER'S STAMP:

PROJECT TITLE: ARLINGTON HOUSING
AUTHORITY
HAUSER BUILDING
FIRE ALARM UPGRADES

37 DRAKE RD ARLINGTON, MA 02476

DRAWING TITLE: SECOND FLOOR DEMOLITION PLANS


DRAWING REVISIONS: DATE DESCRIPTION

AS NOTED HG 11/18/2021

2021-028.00

FA-0.2



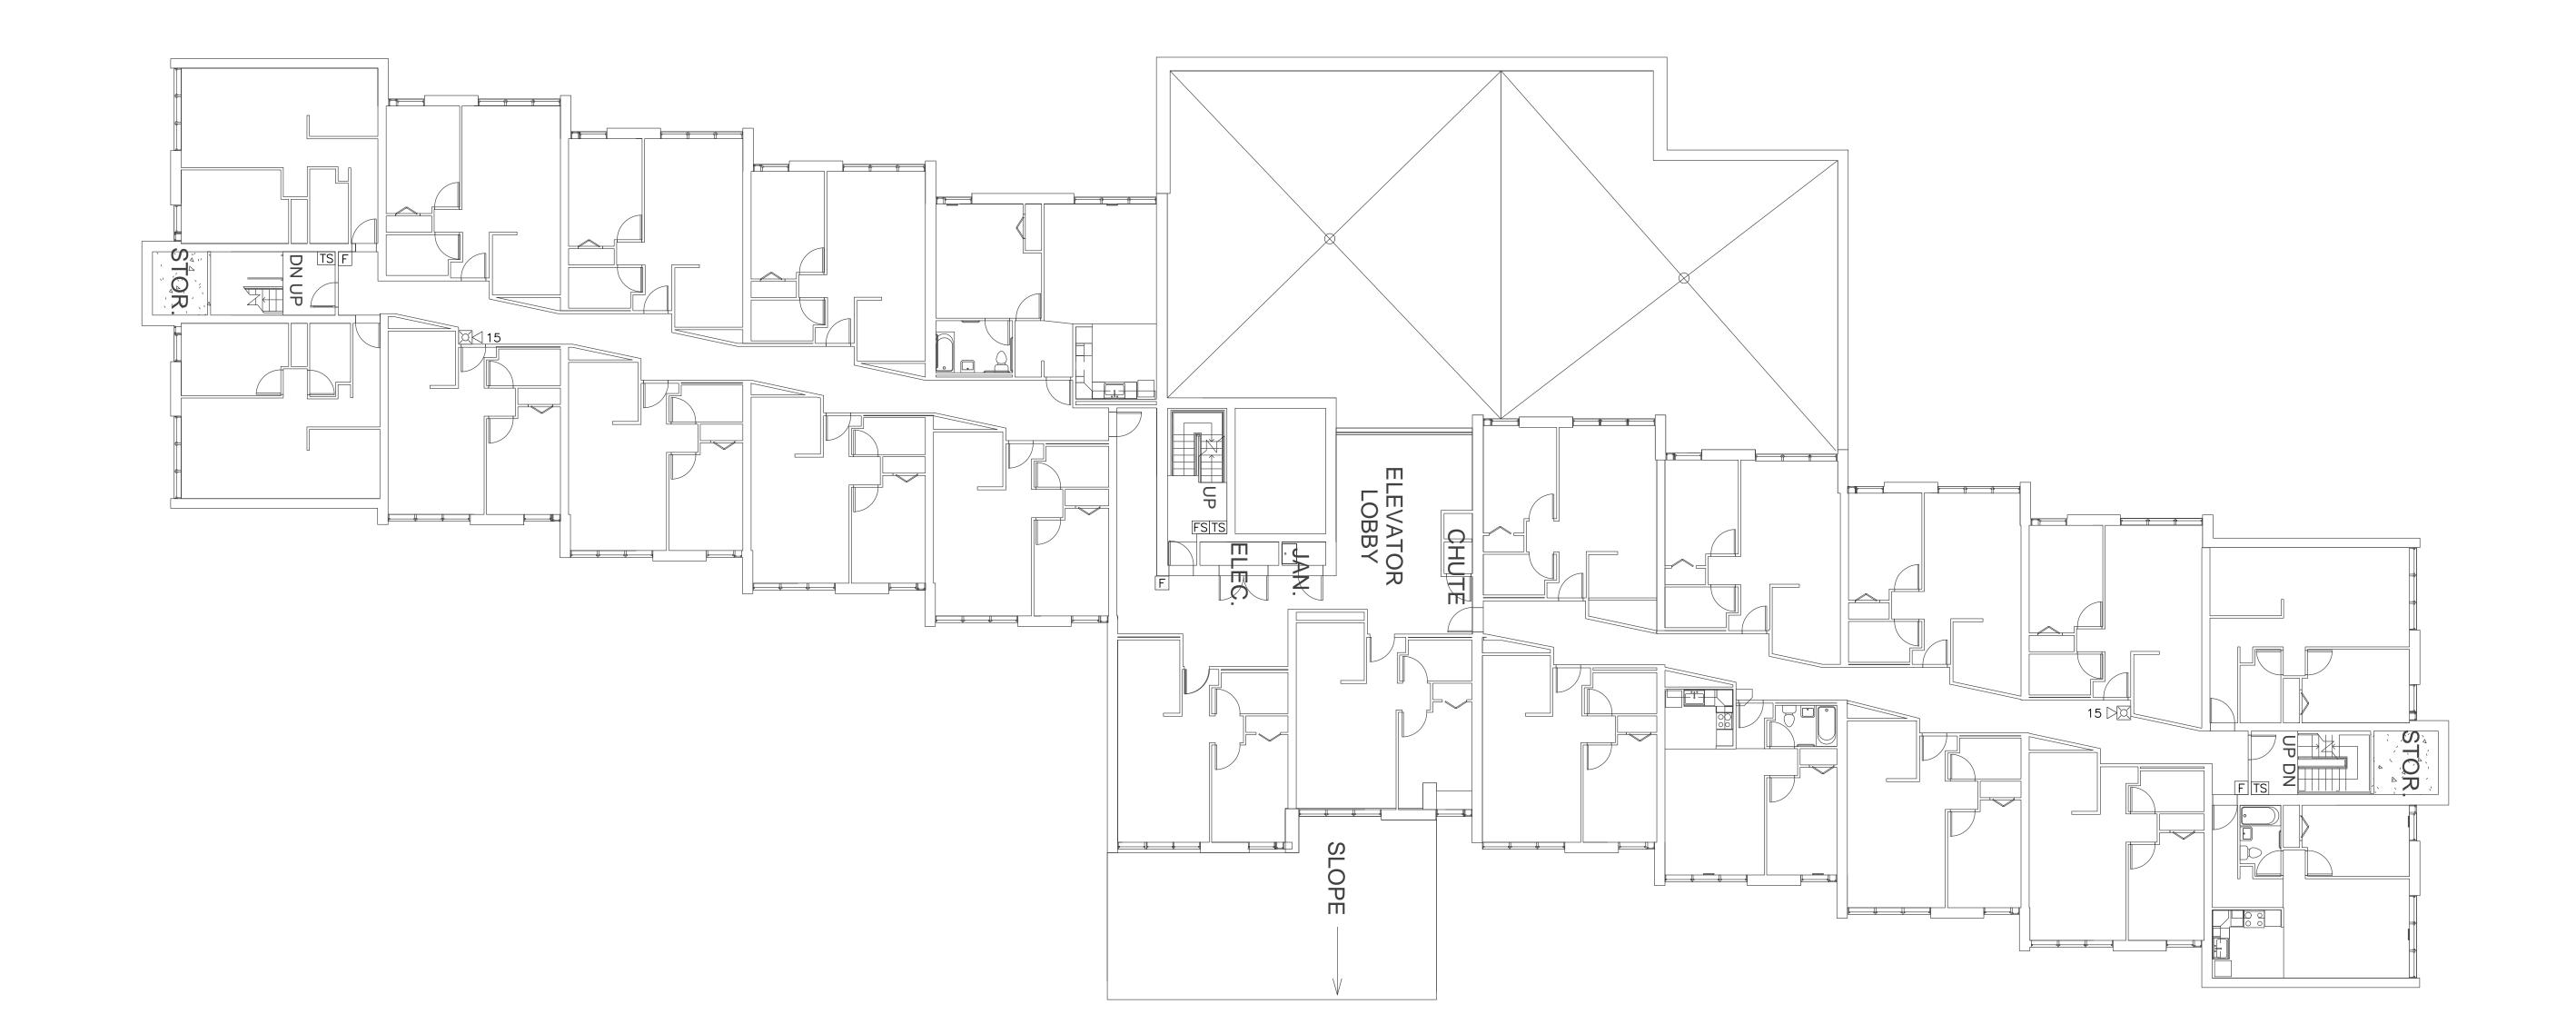

THIRD-SEVENTH FLOOR DEMOLITION PLAN

SCALE: 3/32" = 1'-0"

DEMOLITION NOTES:

1. DEMOLISH ALL FIRE ALARM DEVICES WITH IN TENANT UNITS.

ENGINEER'S STAMP:

PROJECT TITLE:

ARLINGTON HOUSING
AUTHORITY
HAUSER BUILDING
FIRE ALARM UPGRADES

37 DRAKE RD ARLINGTON, MA 02476

THIRD THROUGH
SEVENTH FLOOR
DEMOLITION PLANS

DRAWING REVISIONS:					
DATE	DESCRIPTION				


	SCALE:	AS NOTED
	DRAWN BY:	SK
	CHECKED BY:	HG
	DATE:	11/18/2021
- 1		

FILENAME: 2021-028.00 PROJECT NO:

FA-0.3

SHEET NUMBER



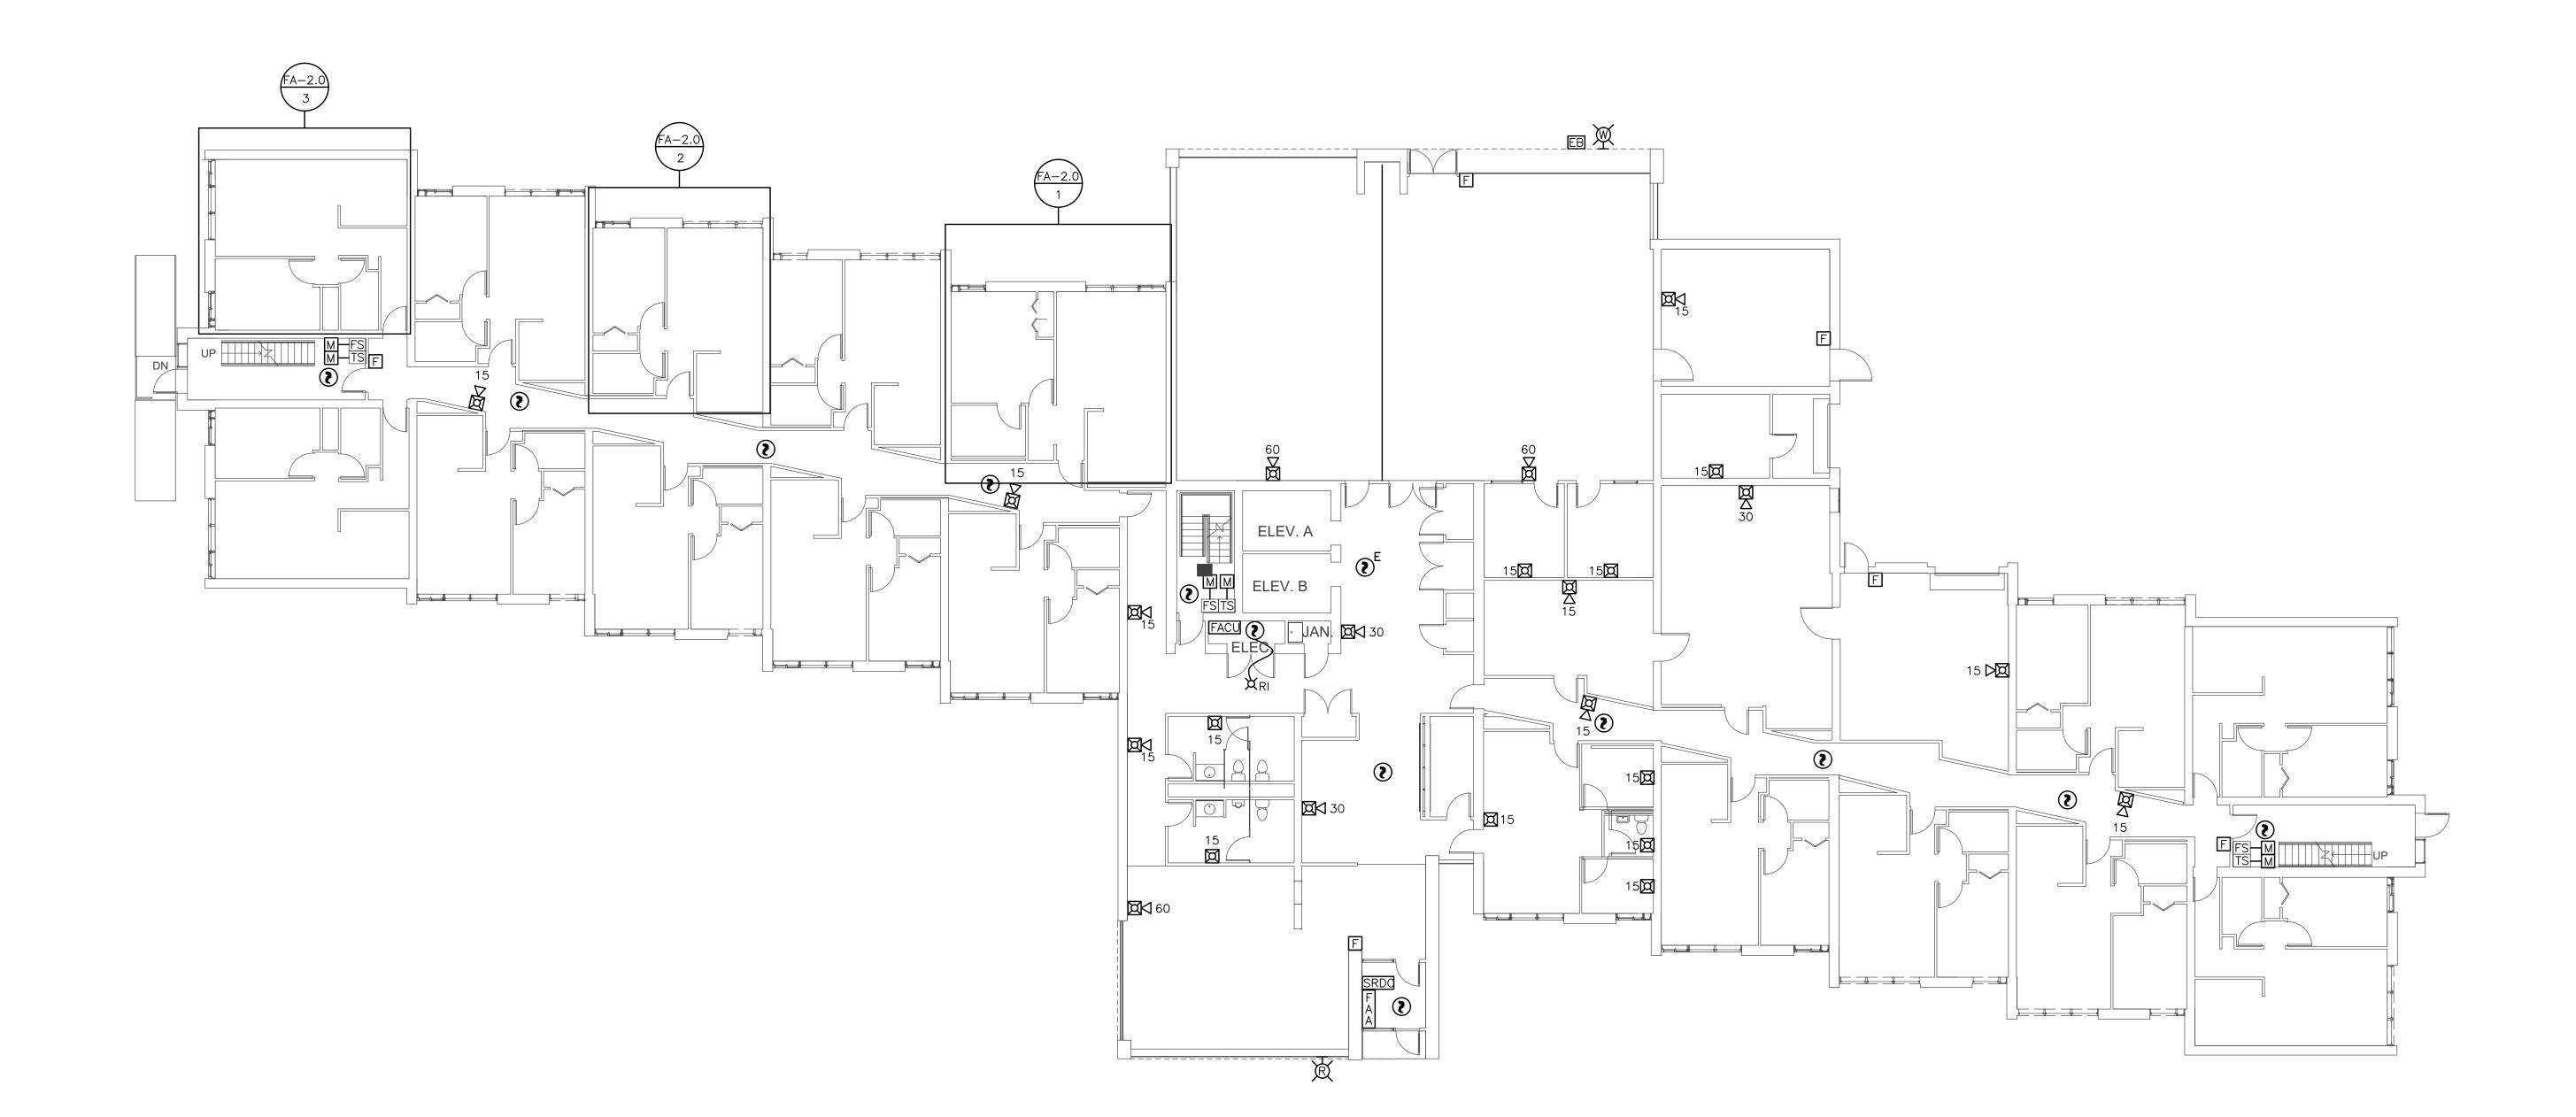

ENGINEER'S STAMP:

PROJECT TITLE:

ARLINGTON HOUSING
AUTHORITY
HAUSER BUILDING
FIRE ALARM UPGRADES

37 DRAKE RD ARLINGTON, MA 02476

DRAWING TITLE:
FIRST FLOOR FIRE
ALARM PLANS

DRAWING REVISIONS:

DATE DESCRIPTION

 SCALE:
 AS NOTED

 DRAWN BY:
 SK

 CHECKED BY:
 HG

 DATE:
 11/18/2021

FILENAME:


2021-028.00

ROJECT NO:

FA-1.0

FIRST FLOOR FIRE ALARM PLAN
SCALE: 3/32" = 1'-0"



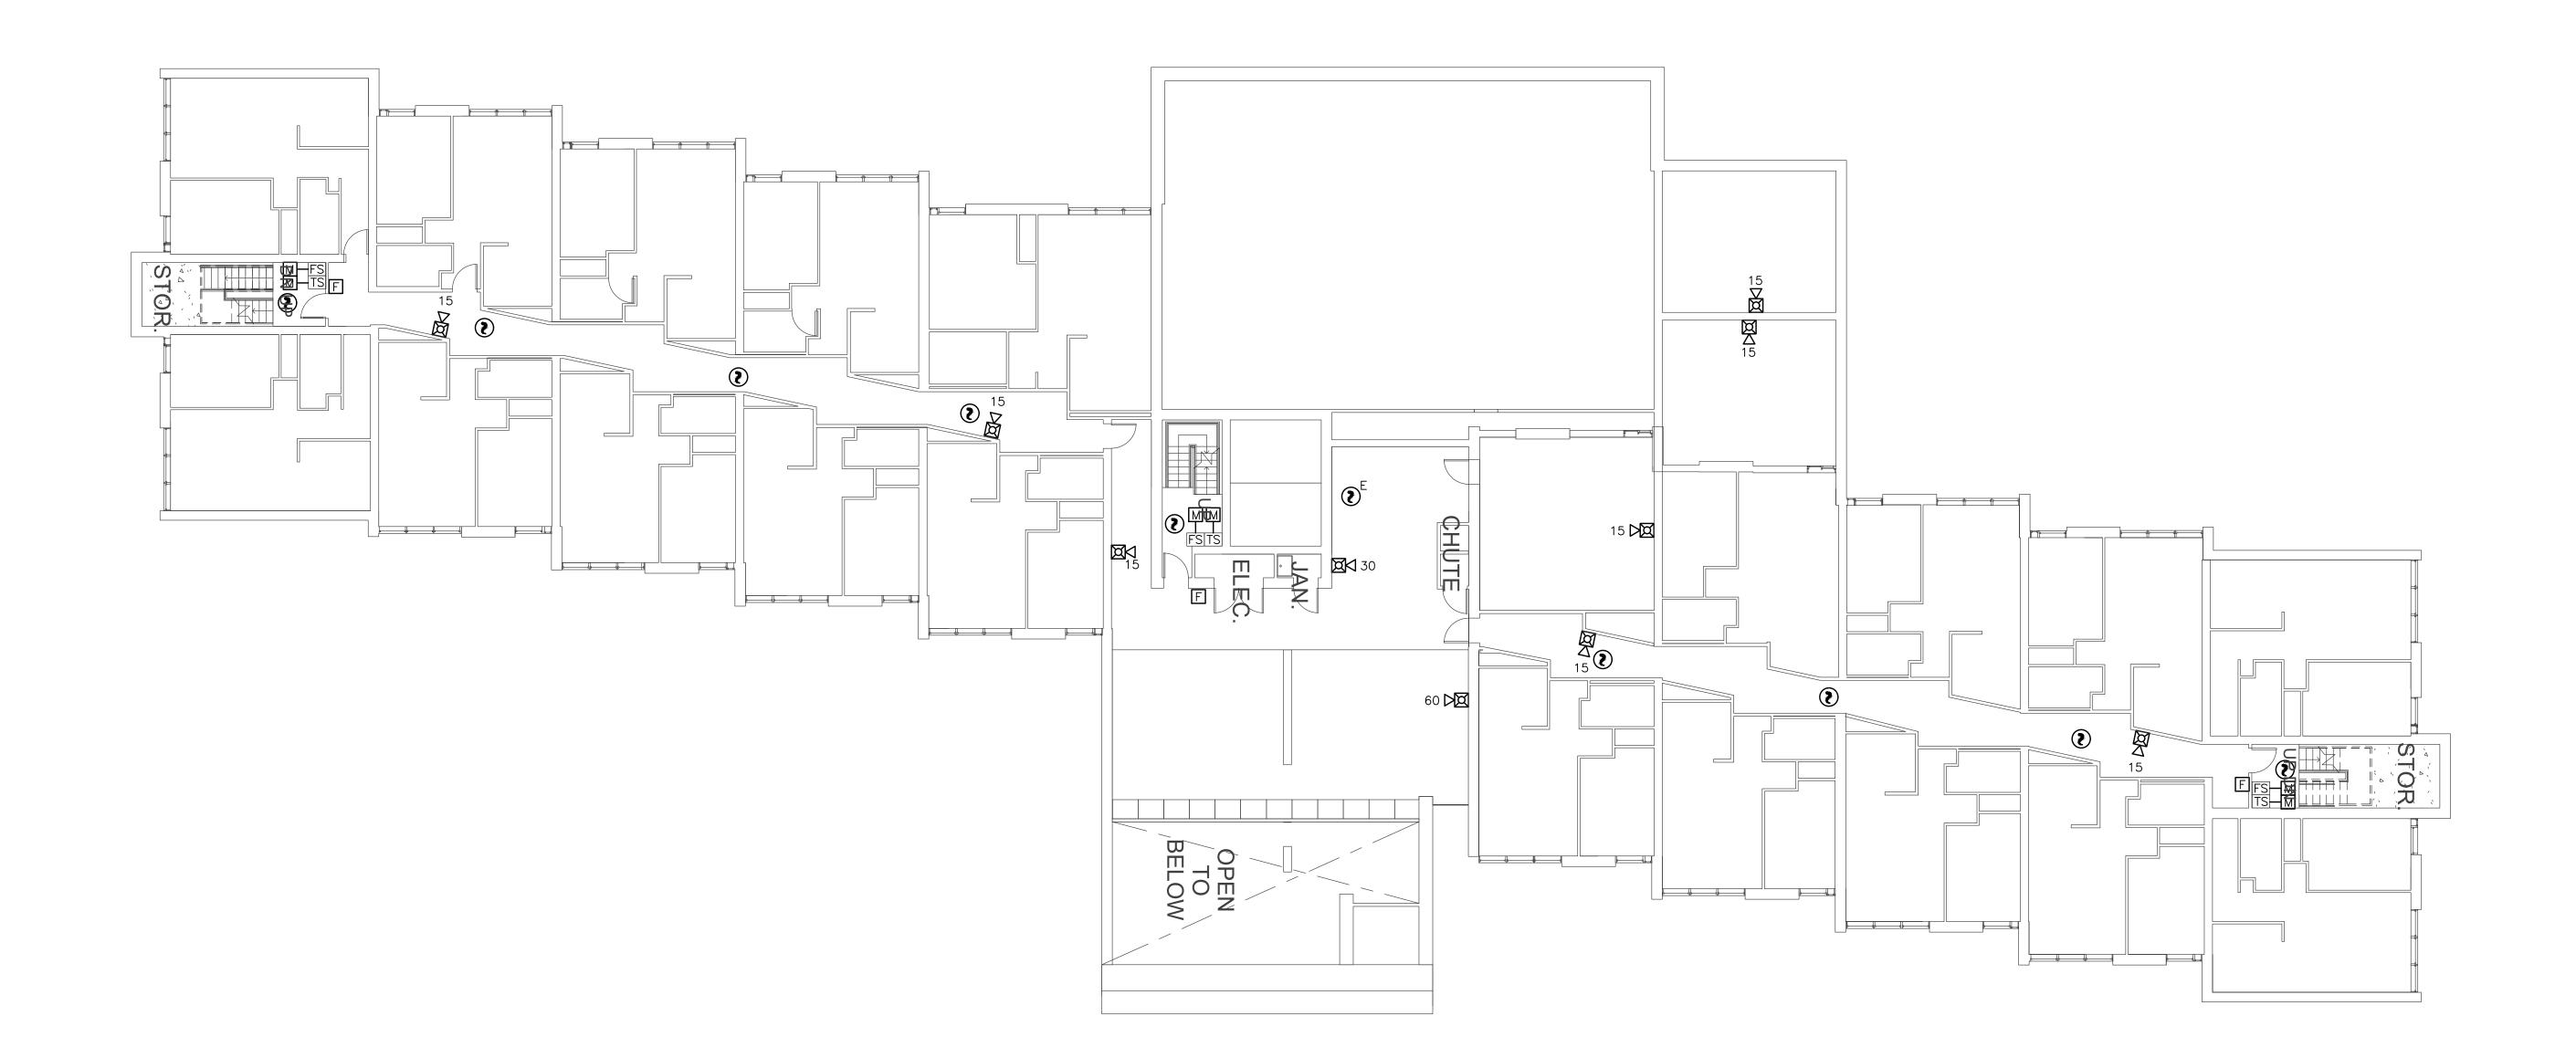

ENGINEER'S STAMP:

PROJECT TITLE: ARLINGTON HOUSING
AUTHORITY
HAUSER BUILDING
FIRE ALARM UPGRADES

37 DRAKE RD ARLINGTON, MA 02476

DRAWING TITLE: SECOND FLOOR FIRE ALARM PLANS

DRAWING REVISIONS: DATE DESCRIPTION

AS NOTED SK HG 11/18/2021


2021-028.00

FA-1.1

SECOND FLOOR FIRE ALARM PLAN

SCALE: 3/32" = 1'-0"



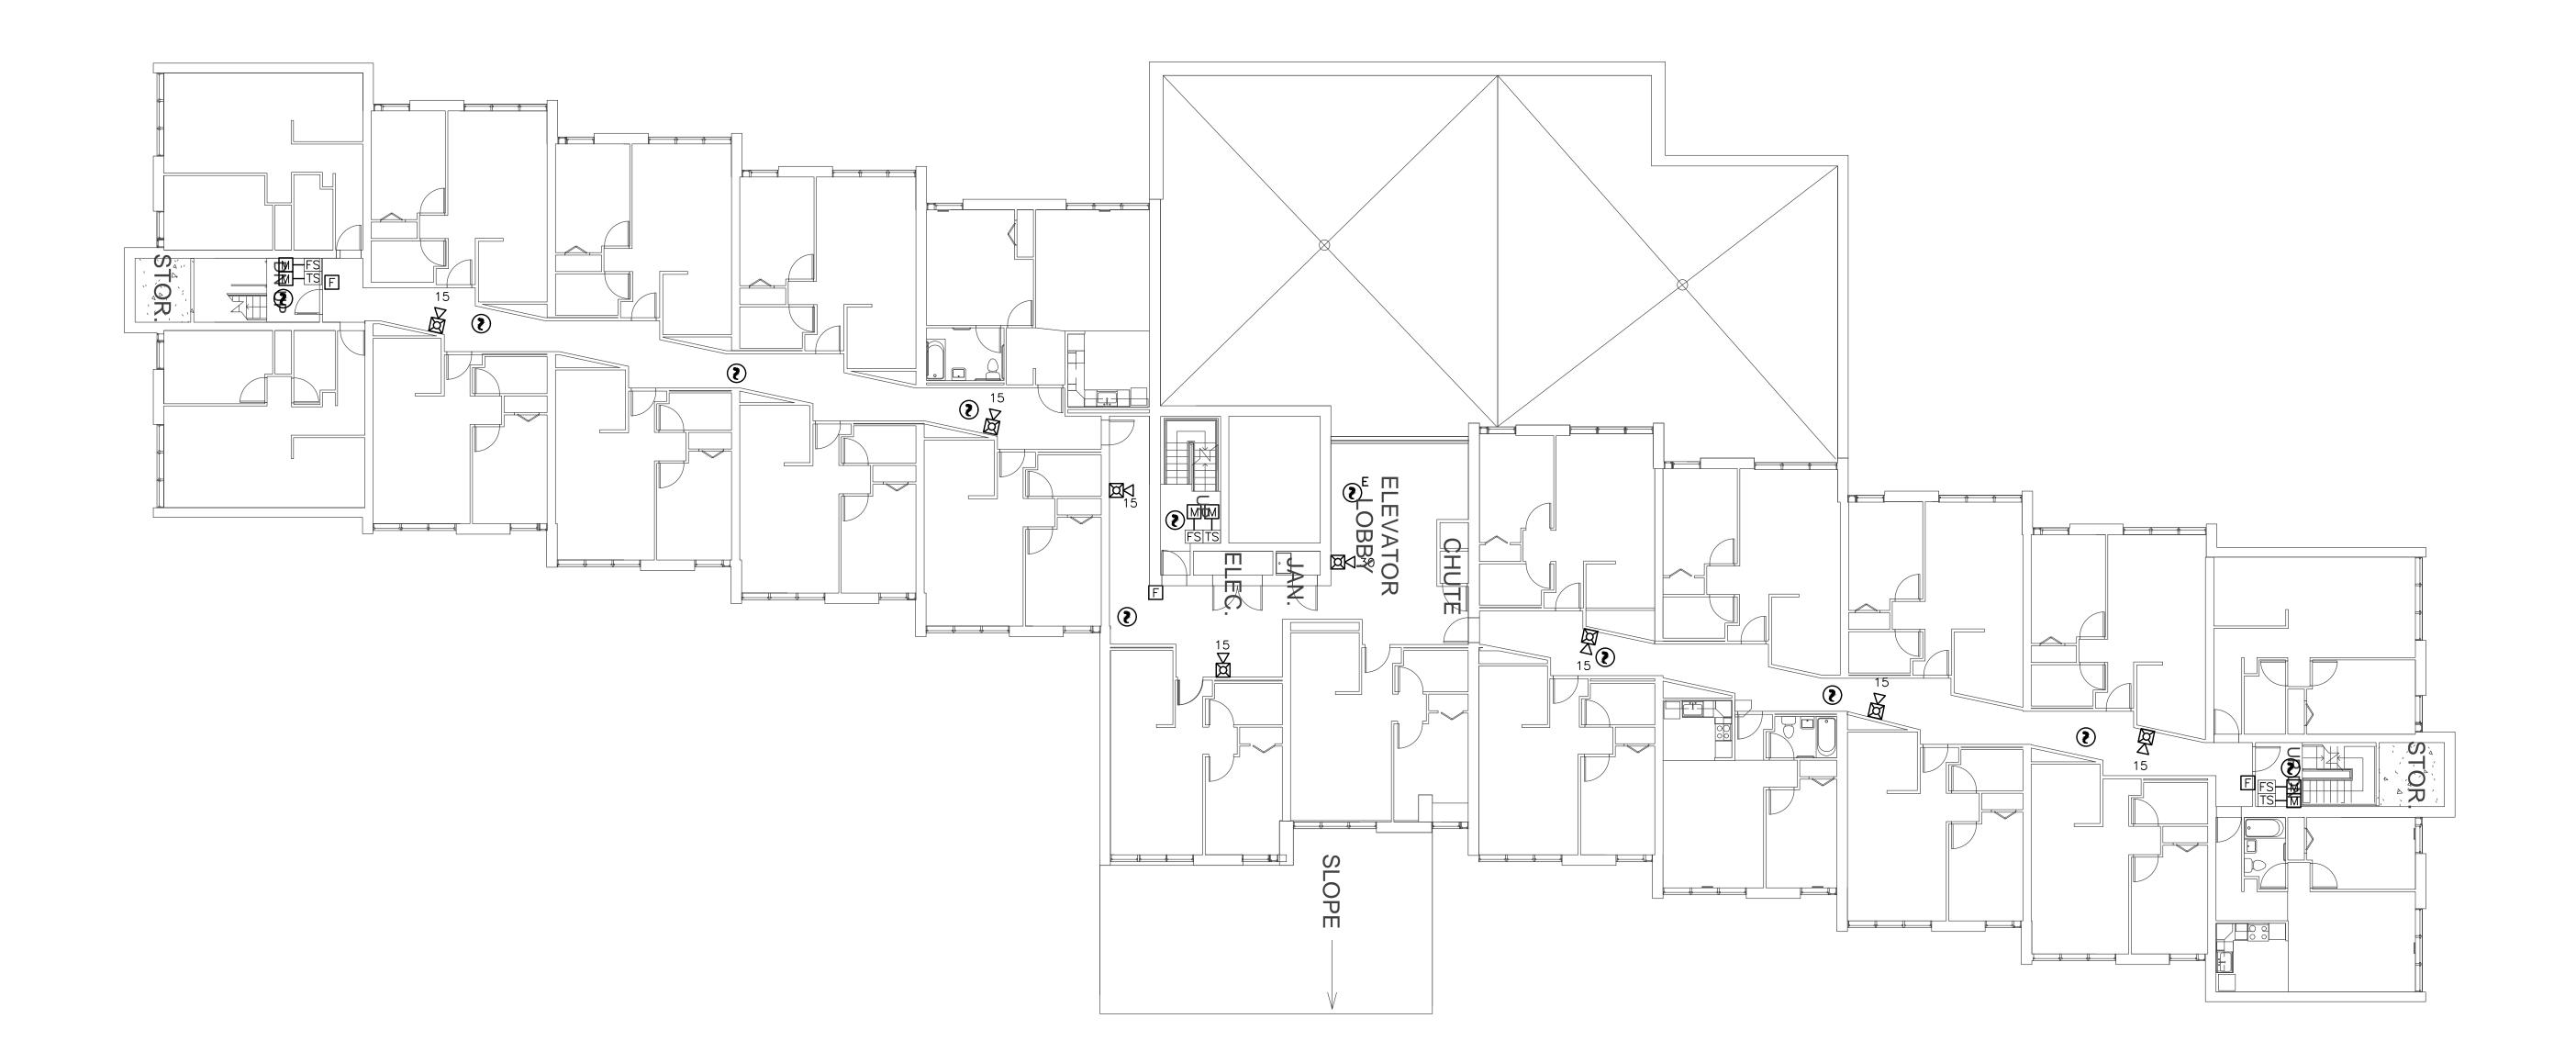

THIRD-SEVENTH FLOOR FIRE ALARM PLANS

SCALE: 3/32" = 1'-0"

ENGINEER'S STAMP:

PROJECT TITLE:

ARLINGTON HOUSING
AUTHORITY
HAUSER BUILDING
FIRE ALARM UPGRADES

37 DRAKE RD ARLINGTON, MA 02476

DRAWING TITLE:
THIRD THROUGH
SEVENTH FLOOR FIRE
ALARM PLANS

DRAWING REVISIONS:

DATE DESCRIPTION

 SCALE:
 AS NOTED

 DRAWN BY:
 SK

 CHECKED BY:
 HG


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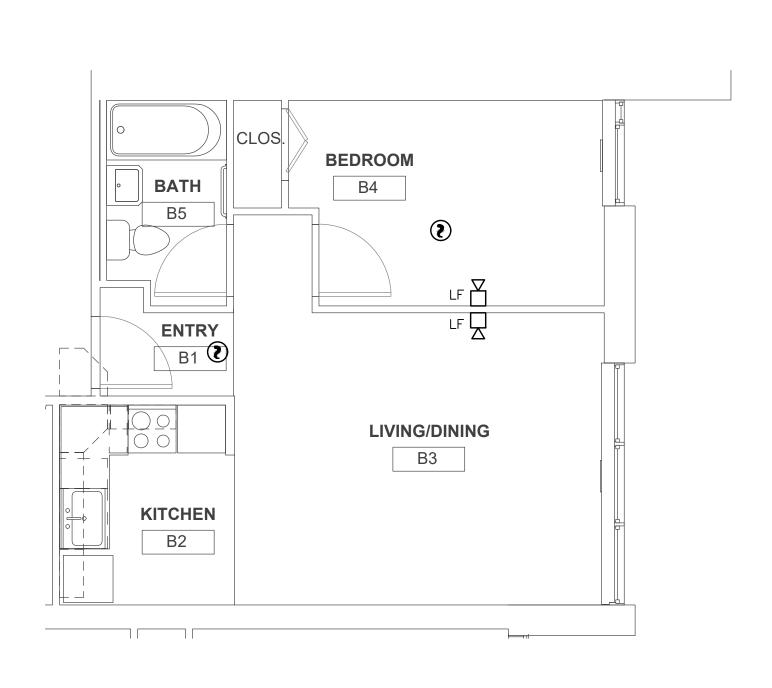
FA-1.2

EET NUMBER








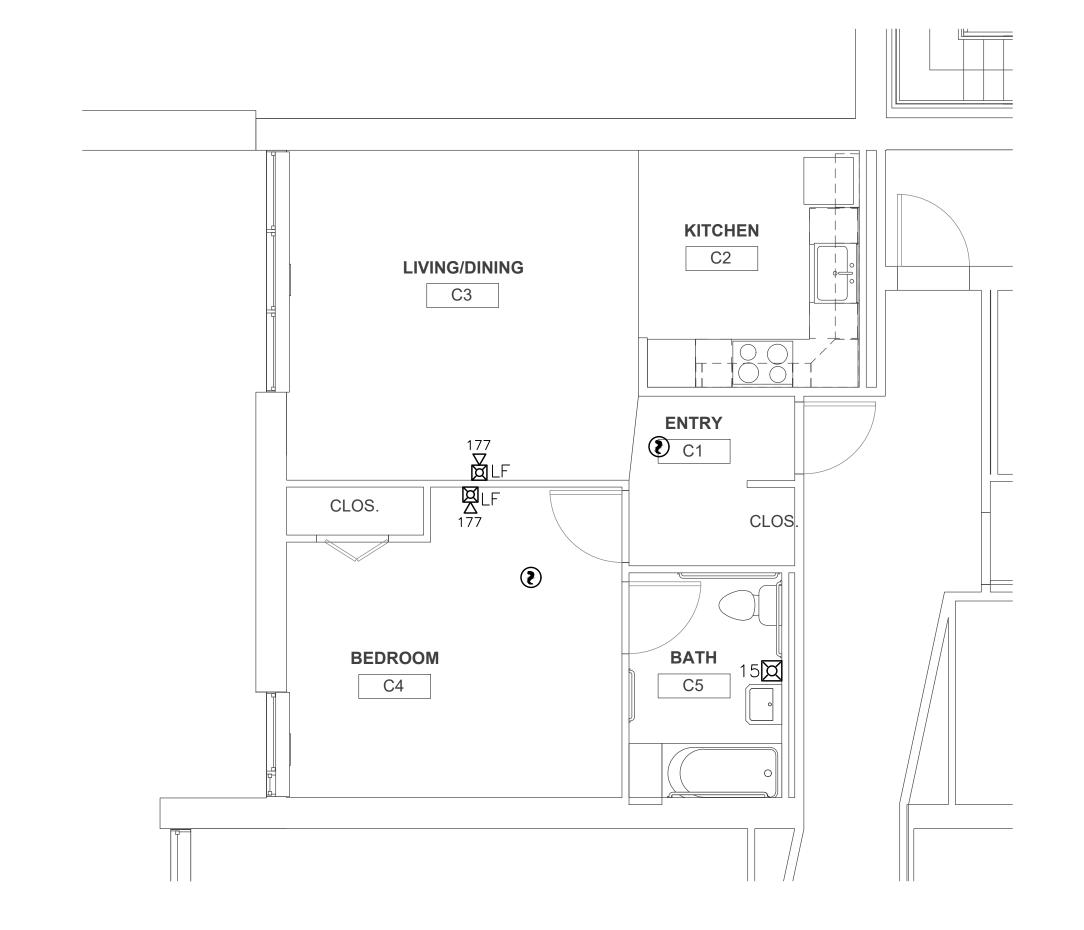

2 TYPICAL MIDDLE UNIT FIRE ALARM PLAN SCALE: 1/4"=1'-0"

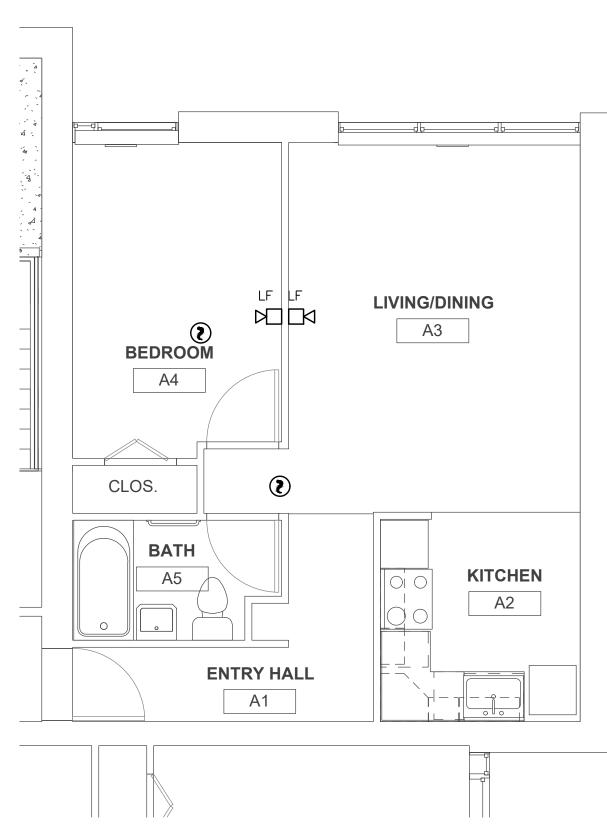

3 TYPICAL END UNIT FIRE ALARM PLAN SCALE: 1/4"=1'-0"

	b <u>db</u> d	
LF LF	LIVING/DINING A3	ENGINEER'S STAMP:

PROJECT TITLE:
ARLINGTON HOUSING
AUTHORITY
HAUSER BUILDING
FIRE ALARM UPGRADES

37 DRAKE RD
ARLINGTON, MA 02476

DRAWING TITLE:

TYPICAL UNIT FIRE
ALARM PLANS

DRAWING REV	ISIONS:
DATE	DESCRIPTION
SCALE:	AS NOTED
DRAWN BY:	SK
CHECKED BY:	HG
DATE:	11/18/2021

FA-2.0

2021-028.00

DHCD FISH #010102

#### PROJECT MANUAL

MODERNIZATION OF STATE AIDED PUBLIC HOUSING

# 667-4 Fire alarm system replacement, #010102

STATE-AIDED DEVELOPMENT: Hauser Building (667-4)
37 Drake Road, Arlington, MA 02476
Arlington, MASSACHUSETTS

# Massachusetts Department of Housing and Community Development Massachusetts

#### **Arlington Housing Authority**

4 Winslow Street Arlington, Massachusetts 02474

Phone: 781-646-3400 Fax: 781-643-6923

#### **BOARD**

Chair: Brian J Connor Vice Chair: Jo Anne Preston Treasurer: Gaar Talanian Member: Fiorella Badilla Member: Nicholas Mitropoulos

#### **Prime Designer:**

Macritchie Engineering 197 quincy ave Braintree, MA 02184 Phone: (781) 848-4464

**DATE: 18 Nov 2021**